

SCIOTO RESERVE

DELAWARE COUNTY, OHIO
JANUARY 1999



GEOGRAPHICAL MAP

NOT TO SCALE

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VICINITY MAP

SCALE: 1"=10000'

APPROVED:

By *Ch. Banscum*

3-24-99 COUNTY ENGINEER, DELAWARE COUNTY
DATE

By *Jack Smelker*

3-24-99 SANITARY ENGINEER, DELAWARE COUNTY
DATE

By *Donald W. Wintz*


3-29-99 DELAWARE COUNTY COMMISSIONER
DATE

By *Debra B. Matz*

3-30-99 DELAWARE COUNTY COMMISSIONER
DATE

BY _____ DELAWARE COUNTY COMMISSIONER
DATE

PLANS PREPARED BY: *Patrick E. Blayney*
PATRICK E. BLAYNEY, P.E. NO. E31768 DATE

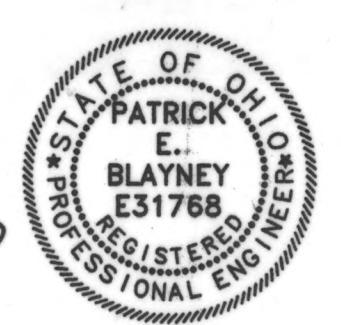

R.D.Zande & Associates

- △ ELIMINATE 2" FORCE MAIN. 1-5-00
- △ ADDED 11.25" BEND, MOVED MANHOLE END INVERT & HEADWALL LOCATION. CHANGED RENO MATTRESS TO DUMPED ROCK FILL.
9-1-99
- △ MOVED MANHOLE LOCATION, PIPE SLOPE, PIPE INVERT ON GRAVITY SEWER.
8/27/99
- △ REVISED HORIZONTAL ALIGNMENT OF FORCE MAIN TO AVOID WATERLINE.
8/25/99

GENERAL NOTES

GENERAL

ALL WORK SHALL BE DONE AND ALL MATERIAL FURNISHED IN ACCORDANCE WITH THE STANDARD DRAWINGS OF THE CONTRACTOR, CONSTRUCTION AND MATERIAL SPECIFICATIONS, LATEST EDITION AND CURRENT DELAWARE COUNTY SPECIFICATIONS. SEWER STANDARD DRAWINGS REFER TO THE DELAWARE COUNTY SANITARY ENGINEERING DEPARTMENT STANDARD DRAWINGS.

COMMENCEMENT OF WORK

THE CONTRACTOR SHALL NOTIFY THE DELAWARE COUNTY SANITARY DEPARTMENT 48 HOURS PRIOR TO COMMENCING WORK ON THIS PROJECT, HOLIDAYS AND WEEKENDS EXCLUDED.

EXTRA COMPENSATION

NO EXTRA COMPENSATION WILL BE PAID TO THE CONTRACTOR BY REASON OF COMPLIANCE WITH ANY OF THE REQUIREMENTS INDICATED IN THE CONTRACT DRAWINGS. PAYMENT SHALL BE DEEMED TO BE INCLUDED AMONG THE PAY ITEMS, AS BID UPON, UNLESS OTHERWISE SPECIFICALLY PROVIDED.

SAFETY REQUIREMENTS

THE CONTRACTOR AND SUBCONTRACTOR SHALL BE SOLELY RESPONSIBLE FOR COMPLYING WITH THE OCCUPATIONAL SAFETY AND HEALTH ACT OF 1970 AND ALL AMENDMENTS THERETO, DURING THE CONDUCT AND PERFORMANCE ON AND IN CONJUNCTION WITH THIS PROJECT.

STATIONING

STATIONING ALONG THE DRAINAGE CHANNELS ARE BASED ON DISTANCES ALONG THE CHANNEL CENTERLINE. BASELINE AND CENTERLINE ARE FIELD LOCATED WITH THE REFERENCE POINTS SHOWN ON THE DRAWING.

BENCHMARKS AND ELEVATIONS

ALL ELEVATIONS SHOWN ARE BASED ON U.S.G.S. DATUM. BENCHMARKS HAVE BEEN SET AT A REASONABLE SPACING. THE CONTRACTOR SHALL CHECK THE ELEVATION ON EACH PERMANENT BENCHMARK PRIOR TO COMMENCING THE WORK. DISCREPANCIES SHALL BE BROUGHT TO THE ATTENTION OF THE COUNTY'S REPRESENTATIVE AND RESOLVED BEFORE PROCEEDING WITH WORK. BENCHMARKS SHALL BE MAINTAINED AND REQUIRED TO COMPLETE THE WORK AT THE CONTRACTOR'S COST.

IRON PINS AND MONUMENTS

THE CONTRACTOR SHALL REFERENCE ALL IRON PINS AND MONUMENTS FOUND BEFORE EXCAVATING AND NEAR THESE COPIES OF REFERENCE DOCUMENTATION SHALL BE SUBMITTED TO COUNTY. IF ANY PINS OR MONUMENTS ARE DESTROYED OR DAMAGED THEY SHALL BE ACCURATELY REPLACED BY A REGISTERED SURVEYOR AT THE COMPLETION OF THE PROJECT AT CONTRACTOR'S COST.

MAINTENANCE OF TRAFFIC

ALL TRAFFIC CONTROL DEVICES SHALL BE FURNISHED, ERECTED, MAINTAINED AND REMOVED BY THE CONTRACTOR IN ACCORDANCE WITH THE "OHIO MANUAL OF CONTROL DEVICES FOR CONSTRUCTION AND MAINTENANCE OPERATIONS" (CURRENT EDITION), COPIES OF WHICH ARE AVAILABLE FROM THE OHIO DEPARTMENT OF TRANSPORTATION, BUREAU OF TRAFFIC, 25 S. FRONT STREET, COLUMBUS, OHIO 43215.

THE CONTRACTOR SHALL NOT BEGIN WORK UNTIL STANDARD BARRICADES AND WARNING SIGNS ARE IN ACCEPTABLE POSITION AND THE MARKERS AND SIGNS CONFORM TO THE "OHIO MANUAL OF UNIFORM TRAFFIC CONTROL DEVICES FOR STREETS AND HIGHWAYS".

TWO-WAY, ONE LANE TRAFFIC SHALL BE MAINTAINED ON HOME ROAD AT ALL TIMES DURING WORKING HOURS IN ACCORDANCE WITH PAGE C-22 OF THE OHIO MANUAL.

THE CONTRACTOR SHALL MAINTAIN LOCAL TRAFFIC AT ALL TIMES DURING CONSTRUCTION OF THIS PROJECT IN A MANNER CAUSING THE LEAST AMOUNT OF INCONVENIENCE TO THE ADJACENT PROPERTY OWNERS. TEMPORARY DIVERSIONS, TEMPORARY ROADWAYS, RUMBLE STRIPS, AND OTHER SURFACE IMPROVEMENTS OR CONSTRUCTION, ETC., ALONG THE CONTRACTOR'S ASSUMES ALL RESPONSIBILITIES AND LIABILITIES REGARDING STRICT ADHERENCE TO APPLICABLE SECTIONS FOR THE MAINTENANCE OF TRAFFIC AND PUBLIC SAFETY AS SET FORTH IN THE "OHIO MANUAL OF UNIFORM TRAFFIC CONTROL DEVICES FOR STREETS AND HIGHWAYS". ALL TRAFFIC CONTROL DEVICES MUST BE IN PLACE PRIOR TO STARTING CONSTRUCTION.

EXCAVATION WHICH ARE NOT PROTECTED BY TEMPORARY FENCING SHALL BE BACKFILLED AT THE END OF EACH WORK DAY.

IF AT ANY TIME TRAFFIC HAS TO BE BLOCKED, THE CONTRACTOR SHALL NOTIFY THE NEAREST F. E. AND POLICE DEPARTMENTS (EMERGENCIES ONLY).

NO NON-RUBBER TIRED VEHICLES SHALL BE MOVED ON COUNTY ROADS.

EXISTING UTILITIES

THE CONTRACT DRAWINGS SHOW ALL UTILITIES, WATER, GAS, AND SEWER LINES KNOWN TO EXIST. HOWEVER, THIS DOES NOT GUARANTEE THAT ALL EXISTING LINES AND APPURTENANCES HAVE BEEN SHOWN ON THE CONTRACT DRAWINGS AND THE COUNTY ASSUMES NO RESPONSIBILITY FOR THE ACCURACY THEREOF AND DOES NOT FREE THE CONTRACTOR FROM NECESSARY PRECAUTIONS FOR THE PROTECTION OF ANY UTILITY ENCOUNTERED ON THE PROJECT OR THE RESTORATION OF ANY UTILITY DAMAGED DURING THE WORK.

THE CONTRACTOR SHALL EXPOSE THE UTILITY OR STRUCTURE INDICATED ON THE DRAWINGS BEFORE COMMENCING THE ASSOCIATED WORK ORDER TO VERIFY THE LOCATION.

THE CONTRACTOR SHALL NOTIFY AT LEAST 48 HOURS BEFORE BREAKING GROUND, ALL PUBLIC AND/OR PRIVATE SERVICE CORPORATIONS HAVING WIRE, POLES, PIPES, CONDUIT, MANHOLES OR OTHER STRUCTURES THAT MAY BE AFFECTED BY THIS OPERATION, INCLUDING ALL STRUCTURES WHICH ARE AFFECTION AND NOT SHOWN ON THESE DRAWINGS. THE CONTRACTOR SHALL CALL THE STATE ENGINEER'S OFFICE OR THE OHIO UTILITIES PROTECTION SERVICE, CAN BE NOTIFIED BY CALLING 800-362-2764 (TOLL FREE). NON-MEMBER UNDERGROUND UTILITY OWNERS MUST BE CALLED DIRECTLY.

THE CONTRACTOR SHALL BE RESPONSIBLE FOR NOTIFYING ALL RESIDENTS OF INTERRUPTION TO THEIR UTILITIES THAT WILL BE CAUSED BY CONSTRUCTION AT LEAST 24 HOURS IN ADVANCE.

SUPPORTING AND/OR PROTECTING EXISTING WATER LINES, GAS MAINS, TELEPHONE CONDUIT, STORM SEWERS, ETC., SHALL BE INCLUDED IN PAYMENT FOR THE VARIOUS CONTRACT ITEMS OF WORK.

ALL MAINTENANCE, PAY AND/OR REPAIR OF EXISTING UTILITIES, WHETHER SHOWN ON THE DRAWINGS OR NOT, SHALL BE IN ACCORDANCE WITH THE RULES AND REGULATIONS OF THE VARIOUS UTILITY COMPANIES HAVING JURISDICTION, AND SHALL BE INCLUDED IN PAYMENT FOR THE VARIOUS CONTRACT ITEMS OF WORK.

ALL EXISTING STORM SEWERS, DRIVEWAY DRAINS, AND OTHER SURFACE DRAIN PIPES, WHETHER SHOWN ON THE CONTRACT DRAWINGS OR NOT, REMOVED OR DAMAGED DURING CONSTRUCTION SHALL BE REPAVED AND RECONNECTED BY THE CONTRACTOR AS DIRECTED BY THE ENGINEER, AT NO COST TO THE COUNTY.

USE OF PREMISES

IN ADDITION TO DIRECT REQUIREMENTS OF THE CONTRACT SPECIFICATION, THE CONTRACTOR SHALL OBSERVE AND COMPLY WITH THE SPECIAL REQUIREMENTS OF ALL RIGHTS OWNED IN INDOORS AND OUTDOORS, COURT ENTRANCE, FRONT-OF-ENTRY, OR ACTION FILED IN COURT IN ACCORDANCE WITH THE CODE OF APPLICABLE GOVERNING AGENCY.

THE CONTRACTOR SHALL NOT TRESPASS UPON OR IN ANY WAY DISTURB PROPERTY ADJACENT TO THE STREET RIGHT-OF-WAY WITHOUT FIRST OBTAINING WRITTEN PERMISSION FROM THE OWNER TO DO SO. A COPY OF SUCH WRITTEN PERMISSION SHALL BE FURNISHED TO THE ENGINEER.

IF THE CONTRACTOR FINDS IT NECESSARY TO OBTAIN ADDITIONAL WORKING AREA, IT SHALL USE HIS DISCRETION FOR ITS ACQUISITION. ALL REQUIREMENTS LISTED UNDER THE USE OF PREMISES SHALL APPLY IF ADDITIONAL AREA IS OBTAINED.

THE CONTRACTOR SHALL, AT HIS OWN EXPENSE, RESTORE SUCH PROPERTY TO THE FULL STATE OF OWNERSHIP. THE OWNER SHALL RECEIVE FROM THE OWNER A WRITTEN RELEASE STATING THAT RESTORATION HAS BEEN SATISFACTORILY MADE. A COPY OF THE WRITTEN RELEASE SHALL BE FURNISHED TO THE ENGINEER.

THE CONTRACTOR SHALL NOT WASTE ANY EXCESS EARTH, STONE, OR OTHER EXCAVATED MATERIAL ON ANY PROPERTY WITHOUT FIRST OBTAINING WRITTEN PERMISSION OF THE OWNER OF THE PROPERTY AND SECURING THE APPROVAL OF THE ENGINEER. ONE COPY OF THE OWNER'S WRITTEN PERMISSION AND ONE COPY OF A WRITTEN RELEASE FROM THE OWNER STATING THAT THE WORK HAS BEEN COMPLETED SATISFACTORILY, SHALL BE FURNISHED TO THE ENGINEER.

ALL ITEMS WITHIN THE STREET RIGHT-OF-WAY SHALL BE REMOVED, OR REMOVED AND REPLACED, OR RESTORED AS REQUIRED BY THE CONTRACT DRAWINGS AND DETAILED PROVISIONS, AS DIRECTED BY THE ENGINEER.

STORAGE OF MATERIALS

THE CONTRACTOR SHALL NOT PARK EQUIPMENT OR STORE MATERIALS WITHIN THE RIGHT-OF-WAY.

PROTECTION OF TREES

SPECIAL CARE SHALL BE TAKEN TO AVOID DAMAGES TO TREES AND THEIR ROOT SYSTEM. MACHINE EXCAVATION SHALL NOT BE USED WHEN, IN THE OPINION OF THE ENGINEER, IT WOULD ENDANGER THE EXISTING ROOTS. WHERE THE EXCAVATION TRENCH FALLS WITHIN THE LIMITS OF THE LIMB SPREAD, THE LEAVINGS OF HEADERS ACROSS THE TRENCH TO PROTECT ROOTS WILL BE REQUIRED. THE OPERATION OF ALL EQUIPMENT, PARTICULARLY WHEN EMPLOYING BOOMS; THE STORAGE OF MATERIALS; AND THE DEPOSITION OF EXCAVATION SHALL BE CONDUCTED IN THE MANNER WHICH WILL NOT INJURE TREES, TRUNKS, BRANCHES OR THEIR ROOTS.

BRANCHES WHICH OVERHANG THE CONSTRUCTION LINES AND WHICH INTERFERE WITH THE OPERATION OF EQUIPMENT SHALL BE TIED BACK TO AVOID DAMAGE. IF POSSIBLE WHERE INJURY TO BRANCHES IS UNAVOIDABLE, THE BRANCHES SHALL BE SAWED OFF NEATLY AT THE TRUNK OR MAIN BRANCH AND THE CUT AREA SHALL BE PAINTED WITH AN APPROVED TREE PAINT IMMEDIATELY. ANY TREE DAMAGE BEYOND SAVING SHALL BE REMOVED BY THE CONTRACTOR AT HIS OWN EXPENSE, AND IN THE CASE OF TREES LOCATED ON PRIVATE PROPERTY, RESTITUTION SHALL BE MADE TO THE OWNER BY THE CONTRACTOR.

CLEARING AND GRUBBING

TREES AND SHRUBS WITHIN CONSTRUCTION EASEMENT NOT DESIGNATED TO BE SAVED ON THE DRAWINGS MAY BE REMOVED AND SHALL BE DISPOSED OF WITH NO ADDITIONAL COST TO THE COUNTY.

SURPLUS EXCAVATION

THE CONTRACTOR SHALL REMOVE FROM THE SITE ALL SURPLUS EXCAVATION TO A LOCATION ACCEPTABLE BY THE COUNTY.

ENCOUNTERING HAZARDOUS OR TOXIC MATERIALS

IF THE CONTRACTOR ENCOUNTERS ANY ABNORMAL MATERIALS SUCH AS, BUT NOT LIMITED TO, DRUMS, TANKS, OR STAINED EARTH OR ANY UNUSUAL ODOR DURING CONSTRUCTION OPERATION, THE WORK IN THIS AREA SHALL BE TEMPORARILY DISCONTINUED, AND THE CONTRACTOR SHALL PLATE OFF THE AREA CORDED OFF FROM THE COUNTY NOTIFIED. IF THE AREA IS CONSIDERED TO CONTAIN HAZARDOUS OR TOXIC MATERIALS IT MUST BE HANDLED CORRECTLY IN ACCORDANCE WITH LOCAL, STATE, AND FEDERAL LAWS.

DELAWARE COUNTY PERMIT

ALL WORK WITHIN DELAWARE COUNTY ROAD RIGHT-OF-WAY IS SUBJECT TO THE INSPECTION AND APPROVAL OF THE DELAWARE COUNTY ENGINEER. THE CONTRACTOR SHALL NOTIFY THE DELAWARE COUNTY ENGINEER, 100 CHANNING STREET, DELAWARE, OHIO 43015, 48 HOURS IN ADVANCE OF STARTING ANY WORK WITHIN THE COUNTY RIGHT-OF-WAY.

DELAWARE COUNTY NOTIFICATION

THE CONTRACTOR SHALL NOTIFY THE DELAWARE COUNTY ENGINEER, AND COUNTY SANITARY ENGINEER 48 HOURS IN ADVANCE OF COMMENCING ANY WORK.

8.1 EXCAVATION, BACKFILL AND EMBANKMENTS

TOP SOIL

ALL TOP SOIL SHALL BE REMOVED AND STOCKPILED FOR FUTURE COVERING OF THE EXCAVATED OR OTHERWISE DISTURBED AREAS.

BACKFILL AND EMBANKMENT

THE CONTRACTOR SHALL FURNISH AND PLACE ACCEPTABLE MATERIAL AS BACKFILL AND EMBANKMENT AROUND THE STRUCTURES. MATERIALS USED SHALL BE OBTAINED FROM THE POND EXCAVATION AREA. SITE EXCAVATION MAY BE DISPOSED OF ON THE SITE, OR ON OFF-SITE AREAS WHEN REQUIRED. ALL BACKFILL AND EMBANKMENT SHALL BE PLACED SO AS TO MINIMIZE SUBSEQUENT SETTLEMENT.

TOP SOIL PLACEMENT

BACKFILL AND EMBANKMENT SHALL BE MADE TO WITHIN APPROXIMATELY 3 INCHES OF FINAL GRADE, MAKING REASONABLE ALLOWANCE FOR SETTLEMENT. TOP SOIL SHALL THEN BE DISTRIBUTED OVER THE AREA TO THE FINISHED GRADE LINES SHOWN ON THE PLANS. FOREIGN MATERIAL SHALL BE REMOVED FROM THE TOP SOIL AS IT IS PLACED AND THE SURFACE RADED EVENLY.

GRANULAR BACKFILL

GRANULAR BACKFILL, WHERE SHOWN ON THE DRAWINGS, MAY BE CRUSHED STONE OR GRAVEL COMPACTED TO THE THICKNESS SHOWN. THE GRANULAR MATERIAL SHALL BE DEPOSITED AFTER THE SUBGRADES HAVE BEEN LEVELLED AND CLEARED OF ALL DEBRIS AND IMMEDIATELY PRIOR TO THE POURING OF THE CONCRETE SLABS.

THE GRANULAR MATERIAL SHALL MEET THE REQUIREMENTS OF SECTION 310.02, 304.02, STATE OF OHIO, DEPARTMENT OF TRANSPORTATION CONSTRUCTION AND MATERIAL SPECIFICATIONS OR BY OTHER WELL GRADED GRANULAR MATERIAL APPROVED BY THE ENGINEER.

8.2 GRADING, FERTILIZING, AND SEEDING

DESCRIPTION

THE CONTRACTOR SHALL FURNISH ALL LABOR, EQUIPMENT, AND MATERIALS REQUIRED TO ACCOMPLISH THE FINE GRADING, FERTILIZER, AND SEEDING AS SPECIFIED HEREIN.

IF SUITABLE TOPSOIL IS AVAILABLE AS PART OF THE MATERIAL EXCAVATED, IT SHALL BE REMOVED AND STORED SEPARATELY AND USED TO BACKFILL THE TOP 4 INCHES. AFTER THE BACKFILL HAS BEEN GIVEN A REASONABLE TIME TO SETTLE, IT SHALL BE GRADED OFF TO THE FINISHED GRADE. THE TOP 4 INCHES OF TOPSOIL SHALL BE REMOVED AND STORED SEPARATELY. THE TOP 4 INCHES ARE TO BE REMOVED AND THE SOIL CAREFULLY BROUGHT TO THE FINISHED GRADE BY RAISING AN APPLICATION OF NOT LESS THAN 1 POUND PER 100 S.F. OF A 12-7-5 LAWN OR TURF GRADE FERTILIZER SHALL BE UNIFORMLY DISTRIBUTED AND RADED IN. THERE IS NO SUITABLE TOPSOIL AVAILABLE AS PART OF THE WORK, IF THERE IS NO DEPOSITOR OF SUITABLE TOPSOIL, THE CONTRACTOR SHALL FURNISH AND APPLY NOT LESS THAN 2 POUNDS PER 100 S.F. OF 12-7-5 LAWN OR TURF GRADE FERTILIZER THE METHOD ABOVE SPECIFIED.

IMMEDIATELY AFTER THE PREPARATION AND FERTILIZATION OF THE SEED BED, THE SEED SHALL BE THOROUGHLY MIXED AND THEN EVENLY SOWN OVER THE PREPARED AREAS AT THE RATE OF 3 POUNDS PER 1,000 S.F. SEED SHALL BE SOWN DRY OR HYDRAULICALLY.

A. ALL AREAS TO BE SEEDED WHICH ARE CONSIDERED TO BE URBAN IN CHARACTER, AND ANY AREA IMMEDIATELY IN FRONT OF A RESIDENCE, SHALL BE SEEDED WITH THE FOLLOWING MIXTURE: (PERCENTAGES ARE BY WEIGHT)

35 PERCENT KENTUCKY 31 FESCUE (POA PRATENSIS)

55 PERCENT KEEPER RED FESCUE (FESTUCA RUBRA)

5 PERCENT RED TOP (AGROSTIS ALBA)

5 PERCENT WHITE DUTCH CLOVER (TRIFOLIUM REPENS)

B. ALL AREAS IN RIGHT-OF-WAY OR IN EASEMENTS ADJACENT TO RIGHT-OF-WAY AND OTHER THAN THOSE MENTIONED ABOVE, SHALL BE SEEDED WITH THE FOLLOWING MIXTURE:

100 PERCENT KENTUCKY 31 FESCUE (FESTUCA ARUNDINACEA VAR. KY. 31)

THE SEED SHALL BE CAREFULLY AND UNIFORMLY SOWN BY EXPERIENCED AND SKILLED WORKMEN. FOLLOWING THE SOWING, THE SURFACE SHALL BE LIGHTLY RADED AND ROLLED WITH A LIGHT ROLLER. FOLLOWING THE ROLLING, THE AREA SEEDED SHALL BE COVERED WITH 2 INCHES, LOOSE MEASUREMENT, OF VEGETATIVE MULCH, TIED DOWN OR KEPT IN PLACE BY OTHER ACCEPTABLE METHOD.

ALL SEDED AREAS SHALL BE CAREFULLY LOOKED AFTER AND TENDED BY THE CONTRACTOR, WATERING AS NECESSARY TO SECURE A GOOD TURF. SETTLED AREA SHALL BE FILLED, GRADED, AND RESEDED.

SEEDING TIME

ALL FERTILIZING AND SEEDING SHALL BE DONE IN THE MONTHS BETWEEN APRIL AND NOVEMBER. THE CONTRACTOR SHALL MAINTAIN AREAS UNTIL SEEDING IS COMPLETE.

AREAS TO BE SEEDED

ALL THE EMBANKMENTS AND DISTURBED AREAS WITHIN THE PROJECT SITE, ALL ROADWAY EMBANKMENTS, FILLS, AND DITCHES NOT SODDED, SHALL BE SEEDED.

8.3 TEMPORARY SEEDING

THE WORK SHALL CONSIST OF FURNISHING ALL LABOR, EQUIPMENT, AND MATERIALS FOR SEEDING THE AREAS AS DIRECTED BY THE ENGINEER, AND FOR LIMING, FERTILIZING, PREPARING A SEEDBED, AND MULCHING WHEN REQUIRED.

SEED REQUIREMENTS

ALL SEED SHALL BE LABELED OR MARKED IN ACCORDANCE WITH SECTION 907.03 OF THE REVISED CODE OF OHIO. ALL SEED TEMPORARILY STORED ON THE JOB SHALL BE PROTECTED FROM DAMPNESS AT ALL TIMES.

SEEDING

THE VARIETY OF SEED AND RATE OF APPLICATION SHALL BE AS SPECIFIED. UNLESS SPECIFIED OTHERWISE, THE TEMPORARY SEEDING OPERATION MAY BE PERFORMED AT ANY TIME DURING THE YEAR.

DETAILS


NO SEEDBED PREPARATION IS REQUIRED AND NO MULCH IS REQUIRED.

SEEDING SHALL BE MADE BEFORE THE CLOSE OF EACH DAY'S WORK ON ALL AREAS AS SPECIFIED BY THE ENGINEER FOR TEMPORARY SEEDING. SEEDING AND FERTILIZER SHALL BE COVERED TO A DEPTH OF ONE (1) INCH. A RAKE, HARRIER, OR OTHER SUITABLE EQUIPMENT AS APPROVED BY THE ENGINEER, SHALL BE USED TO COVER SEED AND FERTILIZER.

FERTILIZER SHALL BE UNIFORMLY APPLIED ON ALL AREAS TO BE SEEDED AT THE RATE OF 30 POUNDS PER ACRE ON NITROGEN, 30 POUNDS PER ACRE OF P2O5; AND 30 POUNDS PER ACRE OF K2O. (EXAMPLE: THIS SPECIFICATION CAN BE MET BY APPLYING FERTILIZER HAVING AN ANALYSIS OF 10-10-10 AT THE RATE OF 300 POUNDS PER ACRE.)

TEMPORARY SEEDING SCHEDULE

DATES FROM TO (INCLUDES)	KIND OF SEED</
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ELEVATION (FT.)	AREA (ACRES)	ACCUMULATIVE DEPTH (FT.)	VOLUME (ACRES FT.)	CUMULATIVE (ACRES FT.)
908.0	0.37	1	0.7	0.7
909.0	1.04	2	1.2	1.9
910.0	1.44	4	4.6	6.5
912.0	3.16	7	11.3	17.8
915.0	4.35	12	28.3	46.1
920.0	6.97	14	15.7	61.8
922.0	8.70	17	28.7	90.5
925.0	10.43	18	10.5	101.0
926.0	10.55	18	0.0	101.0
926.0	15.28	19.2	18.5	119.6
927.2	15.67	21.2	31.5	151.1
929.2	15.83			

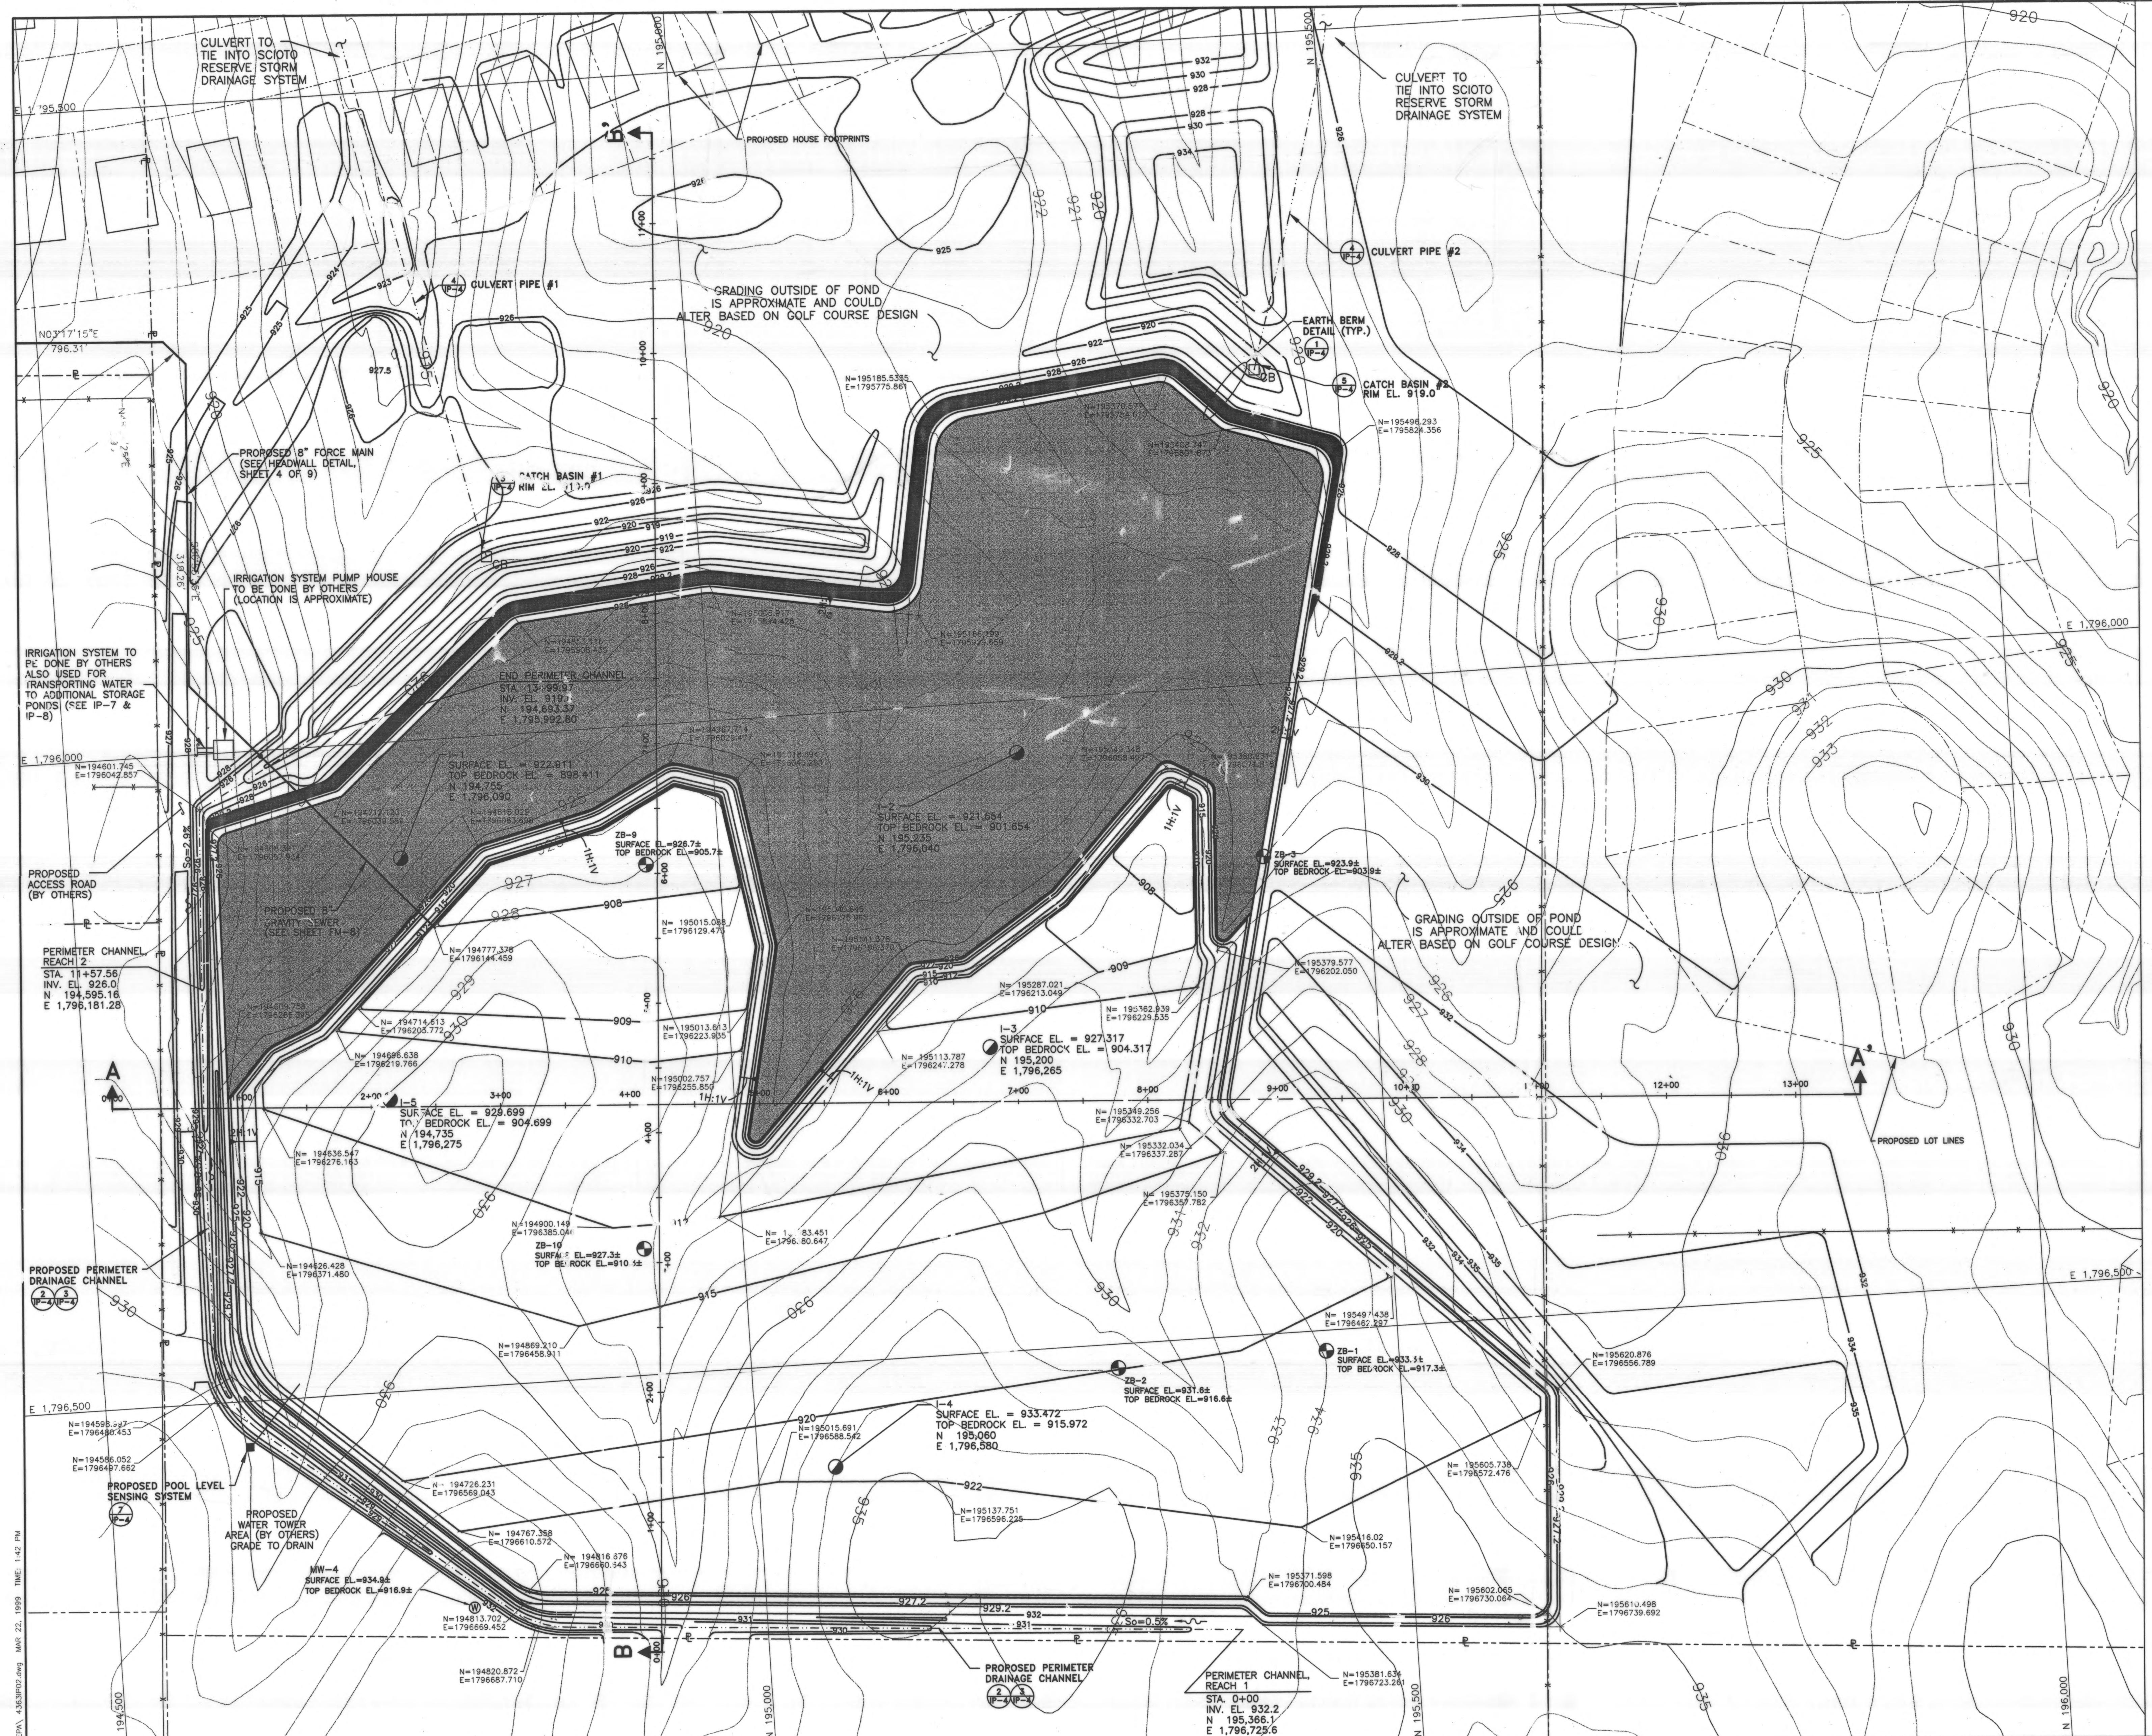REQUIRED STORAGE VOLUME = 166.0 ACFT.


VOLUME ABOVE INSIDE EXISTING TOE = 49.9 ACFT.
(BETWEEN 929.2 - 926.0)

PROXIMATE TOTAL EXCAVATION = 225,000 C.Y.

PROXIMATE AMOUNT OF MATERIAL NEEDED FOR COMPAKTED
WTH BERMS AND PLATEAU = 35,000 C.Y.


PROXIMATE AMOUNT OF TOP SOIL EXCAVATED = 25,000 C.Y.

PROXIMATE AMOUNT OF TOP SOIL NEEDED = 13,500 C.Y.

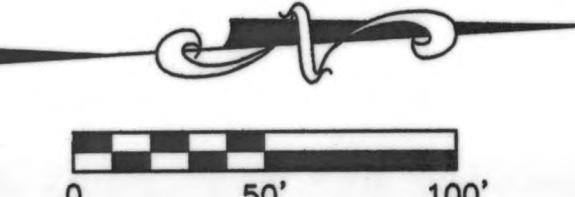


DESIGNED BY:	TAM	REVISIONS	
DRAWN BY:	MDK	DATE	REMARKS
CHECKED BY:	TAM		
APPROVED BY:	JFS		
DATE:	JANUARY 25, 999		
JOB NO.	4363EN		

DELAWARE COUNTY

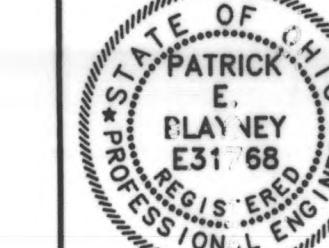


SCIOTO RESERVE IRRIGATION POND

SCALE:	IRRIGATION POND	SHEET NO.
1"=50'	FINAL GRADE PLAN	IP-2

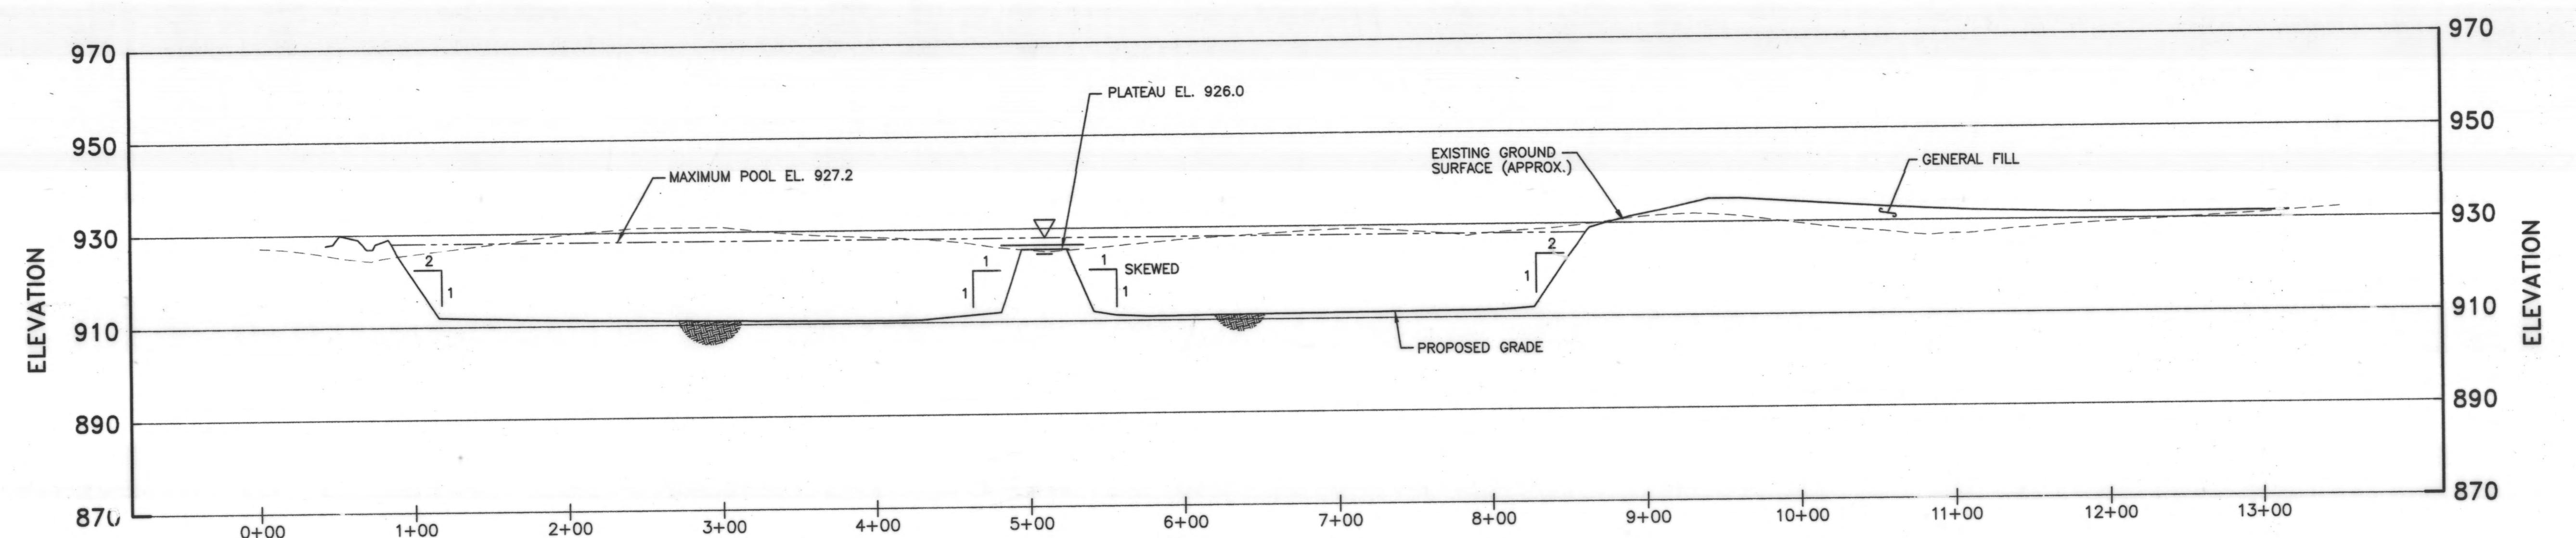

IRRIGATION POND CROSS SECTION A-A'

(LOOKING WEST)



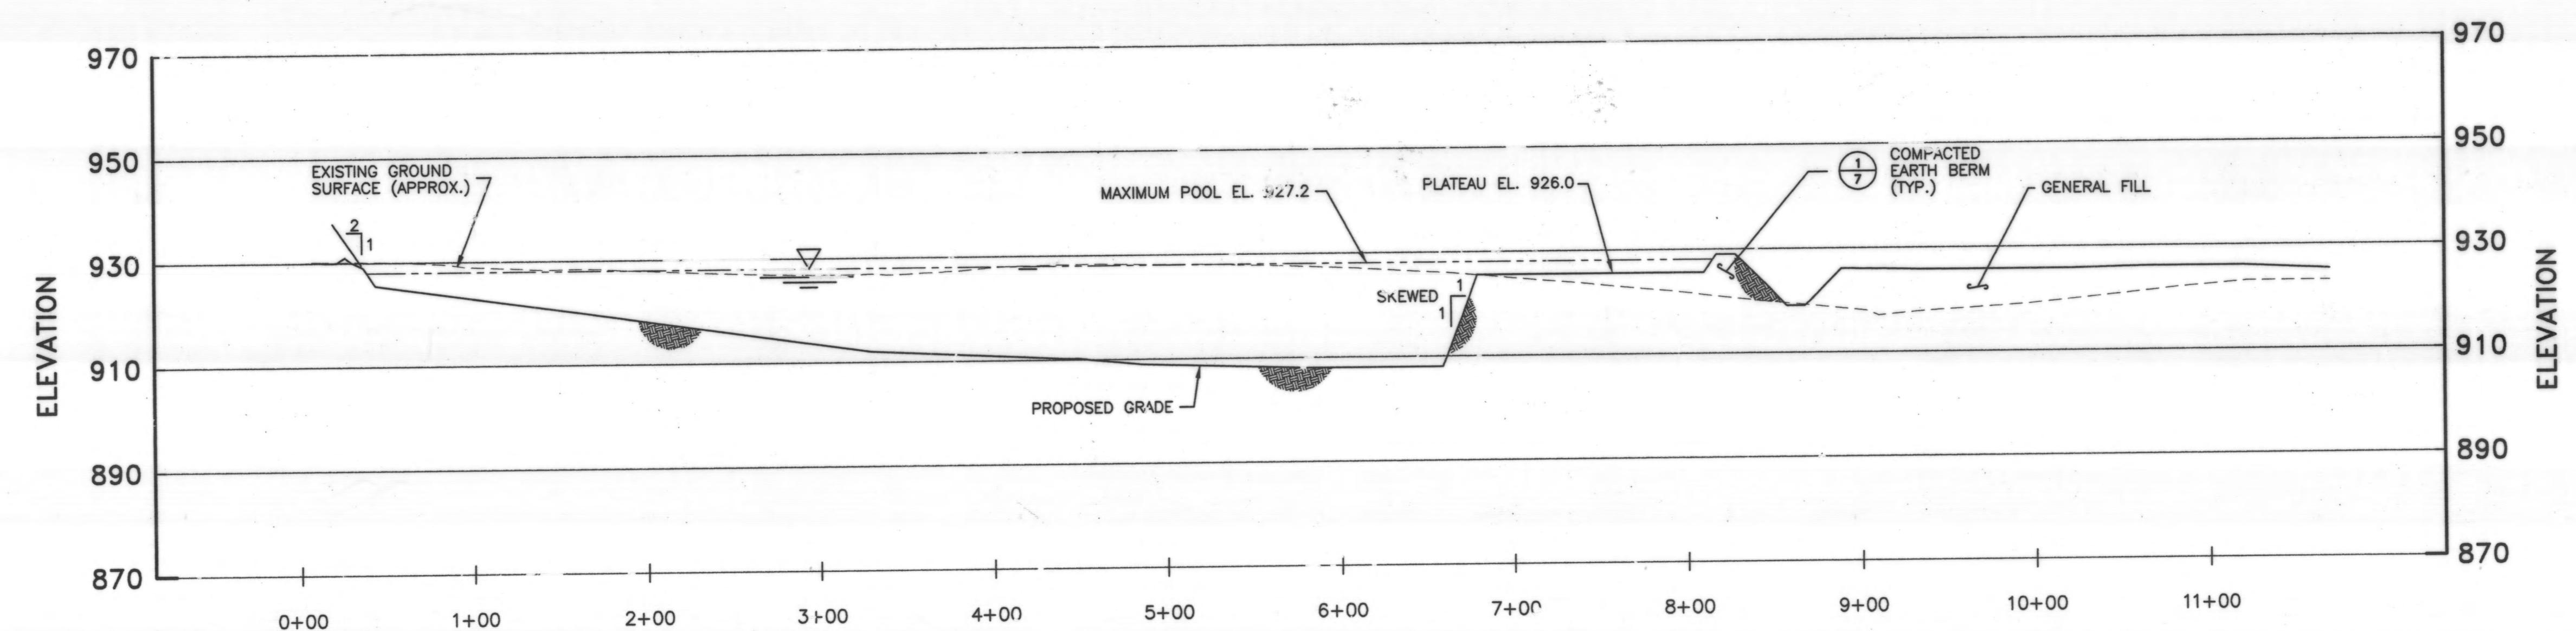


IRRIGATION POND CROSS SECTION B-B'

(LOOKING SOUTH)

HORIZONTAL SCALE
0 60' 120'
VERTICAL SCALE
0 20' 40'

DESIGNED BY:	TAM	REVISIONS	DELAWARE COUNTY DELAWARE COUNTY SANITARY ENGINEER	SCIOTO RESERVE IRRIGATION POND	IRRIGATION POND	CROSS SECTIONS A-A' AND B-B'	SHEET NO.
DRAWN BY:	MDK	DATE					IP-3
CHECKED BY:	TAM						
APPROVED BY:	JFS						
DATE:	JANUARY 25, 1999						
JOB NO.	4363EN						

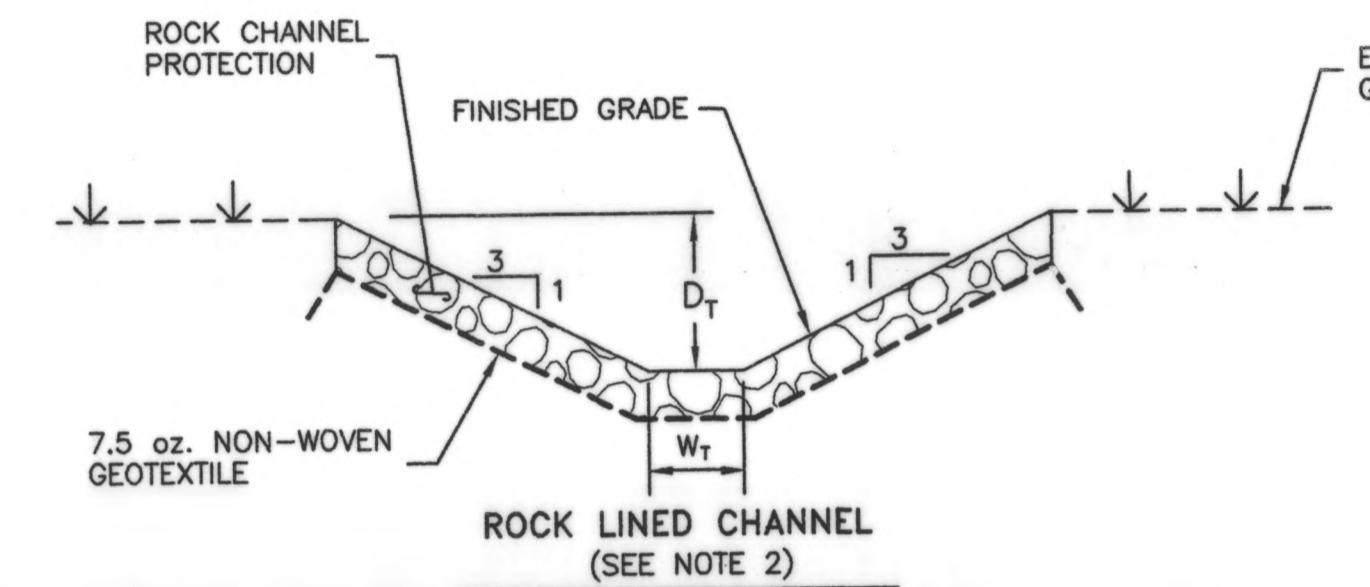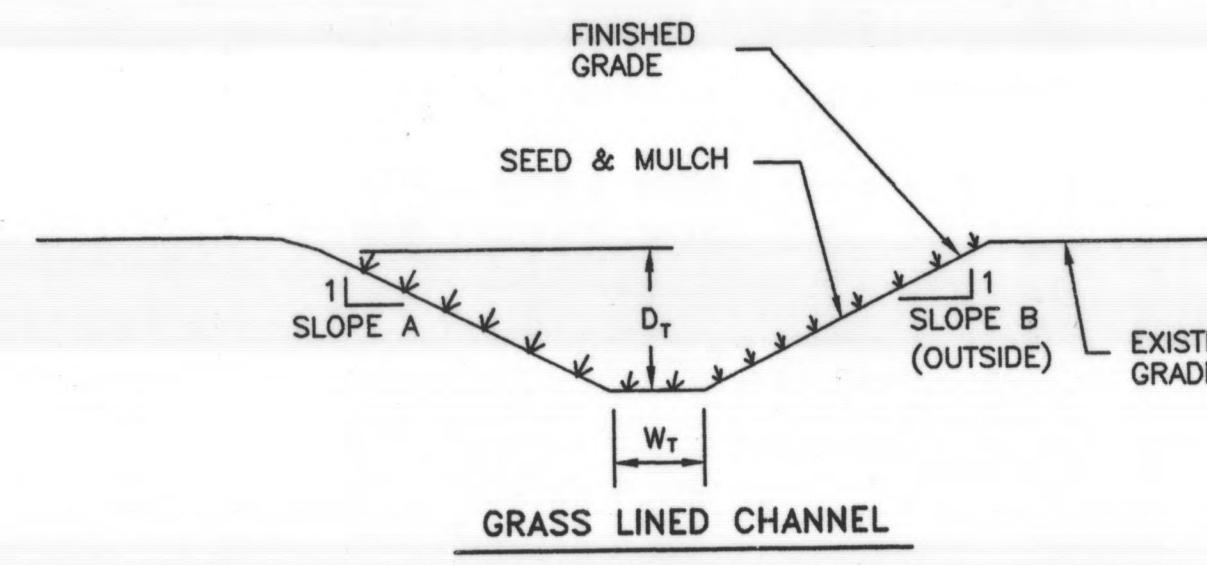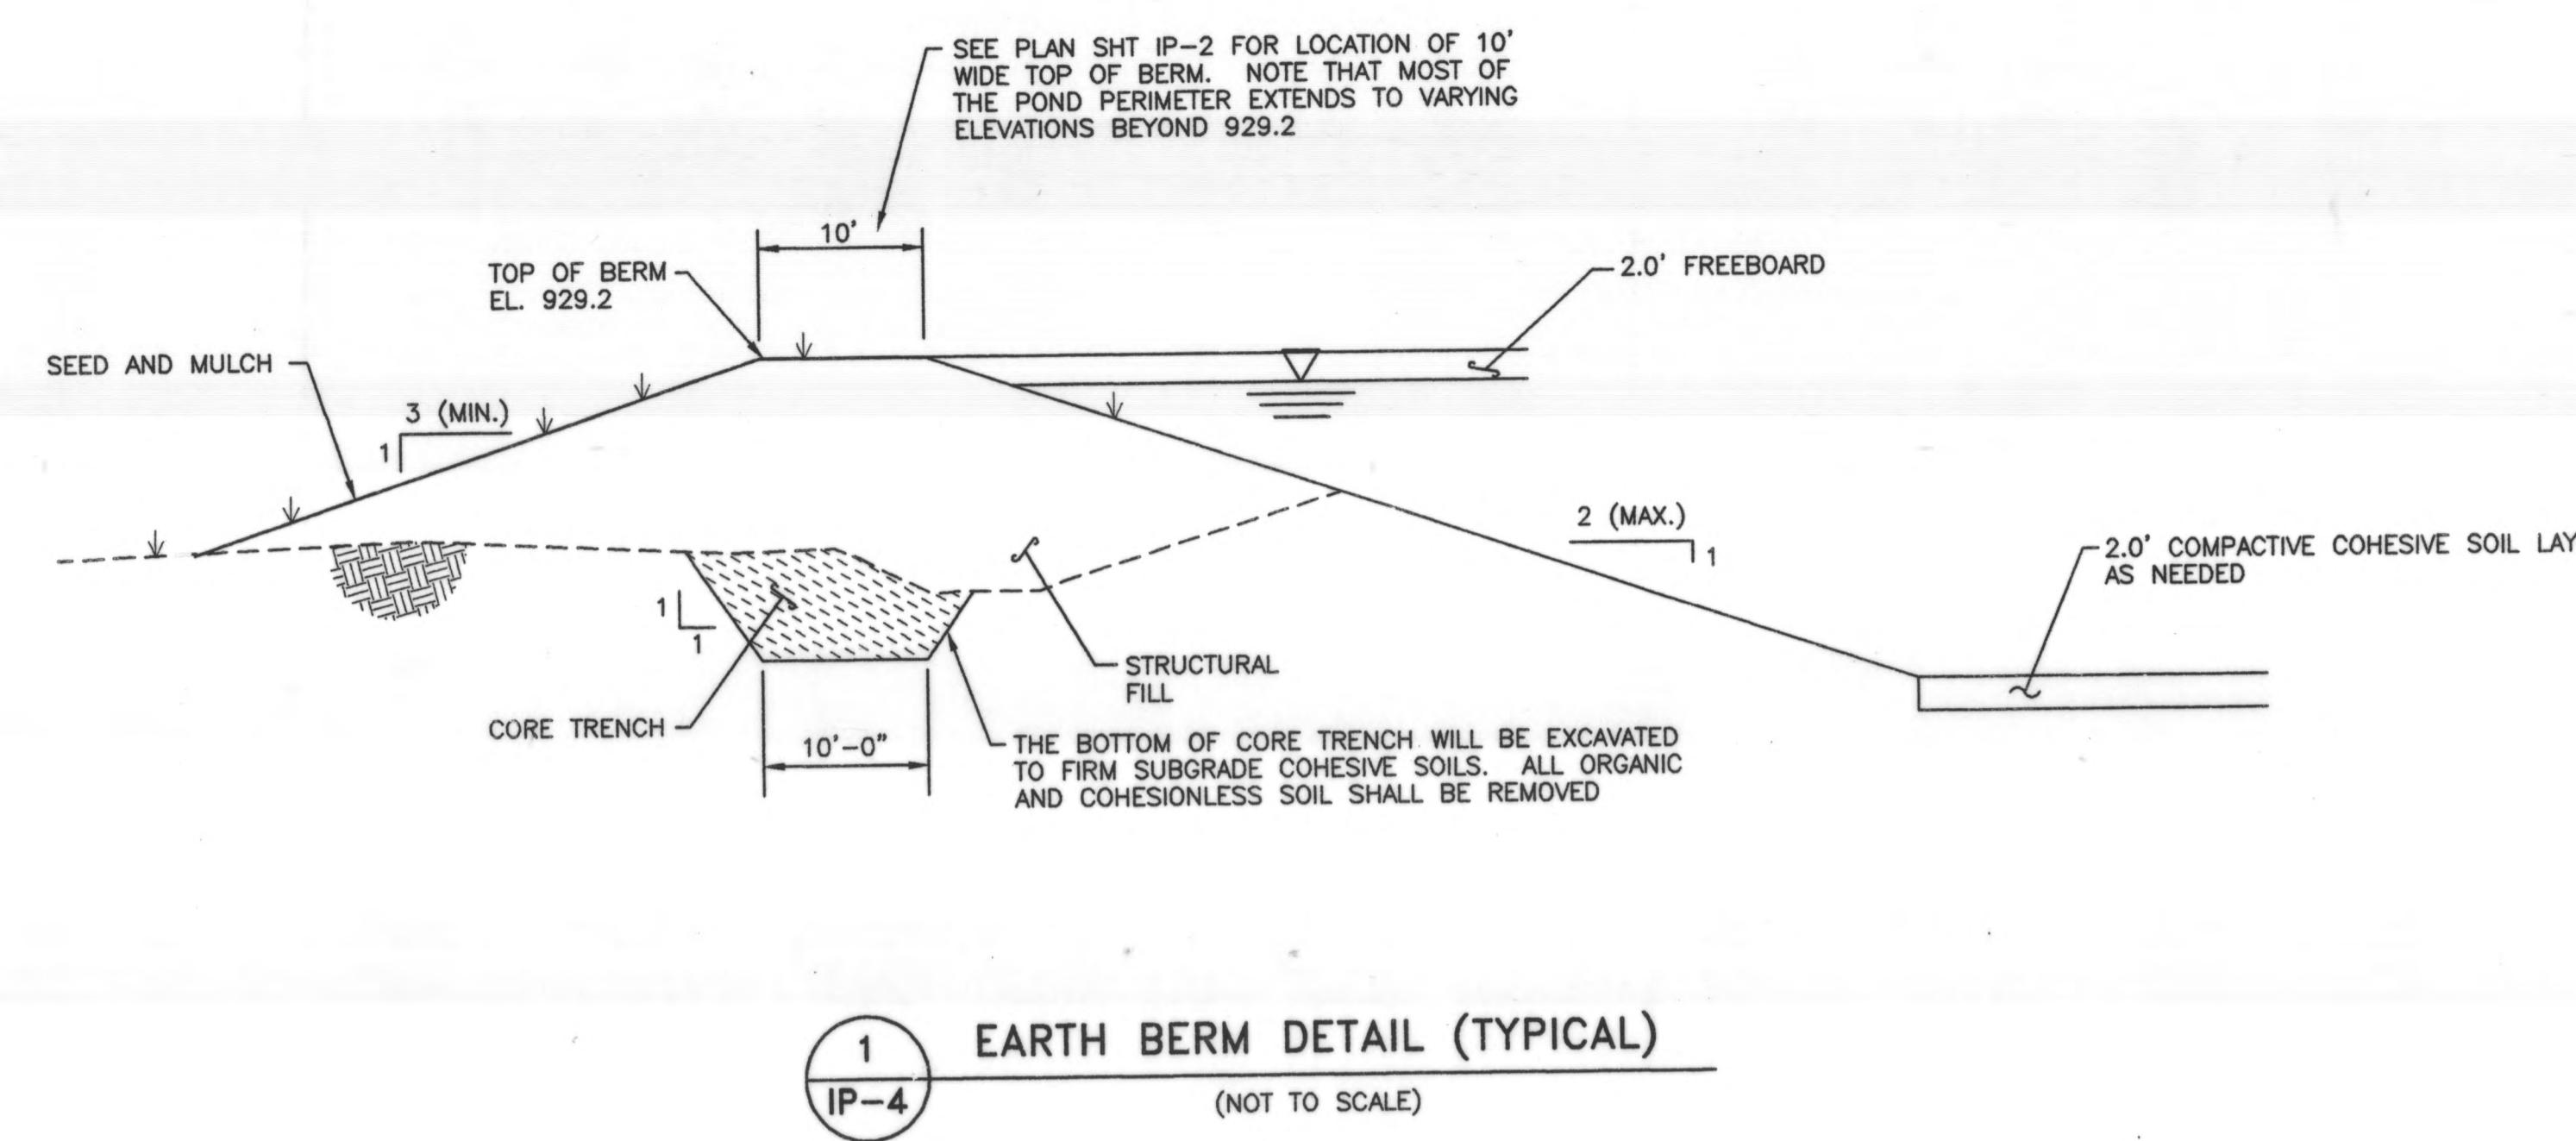


- NOTES:
1. THE CONTRACTOR SHALL DETERMINE THE APPROPRIATE AMOUNT OF EXCAVATION REQUIRED TO INSTALL CHANNELS TO THE FINISHED GRADE. THE CONTRACTOR SHALL NOT BE PAID FOR OVEREXCAVATION OF THESE CHANNELS.
 2. ROCK CHANNEL PROTECTION SHALL BE ODOT TYPE "C" DUMPED ROCK. FILL PLACED TO A MINIMUM LAYER THICKNESS OF 1.0 FOOT.
 3. ONE LAYER OF 7.5 OZ PER S.Y. NON-WOVEN GEOTEXTILE SHALL BE INSTALLED BEneath ROCK CHANNEL PROTECTION AS SHOWN ON THE PLANS AND IN ACCORDANCE WITH THE MANUFACTURER'S REQUIREMENTS. A MINIMUM OF 12 INCHES GEOTEXTILE OVERLAP IS REQUIRED WHEN JOINING TWO SECTIONS OF MATERIAL.
 4. TEMPORARY SEDIMENT TRAPS WILL BE PLACED NEAR THE DOWNSTREAM END OF THE PROPOSED PERIMETER DRAINAGE CHANNEL AT 15 FOOT INTERVALS AND SHALL REMAIN IN PLACE UNTIL VEGETATION GROW IN THE GRASS LINED CHANNEL IS SUFFICIENT TO PERMIT THEIR REMOVAL. THE CONTRACTOR SHALL PLACE TEMPORARY SEDIMENT TRAPS AT OTHER LOCATIONS AS NEEDED.
 5. CATCH BASINS AND CULVERTS ARE SHOWN FOR INFORMATION PURPOSES ONLY. CATCH BASINS AND CULVERTS SHOWN ON THIS PLAN SHEET ARE TO BE CONSTRUCTED BY THE GOLF COURSE CONTRACTOR.
 6. THE PRIMARY AND SECONDARY IRRIGATION IMPOUNDMENTS WILL BE EXCAVATED TO BOTTOM OF RECOMPACTED SOIL LINER GRADES. A 2 FOOT RECOMPACTED COHESIVE SOIL LINER WILL BE CONSTRUCTED FOR THE BOTTOM AND SIDE SLOPES OF BOTH THE PRIMARY AND SECONDARY IMPOUNDMENTS. ANY LIFT PENETRATIONS MADE INTO THE COHESIVE SOIL LINER SHALL BE BACKFILLED WITH BENTONITE / WATER MIXTURE.

3 IP-4

CHANNEL SCHEDULE

DRAINAGE CHANNEL	REACH	LENGTH (ft.)	SLOPE (ft./ft.)	SIDE SLOPE A	SIDE SLOPE B	BOTTOM WIDTH W _b (ft.)	TOTAL DEPTH D _t (ft.)	LINING
PERIMETER	1	1157	0.005	3	3	4	2.5	GRASS
	2	242	0.029	3	3	4	2.5	ROCK

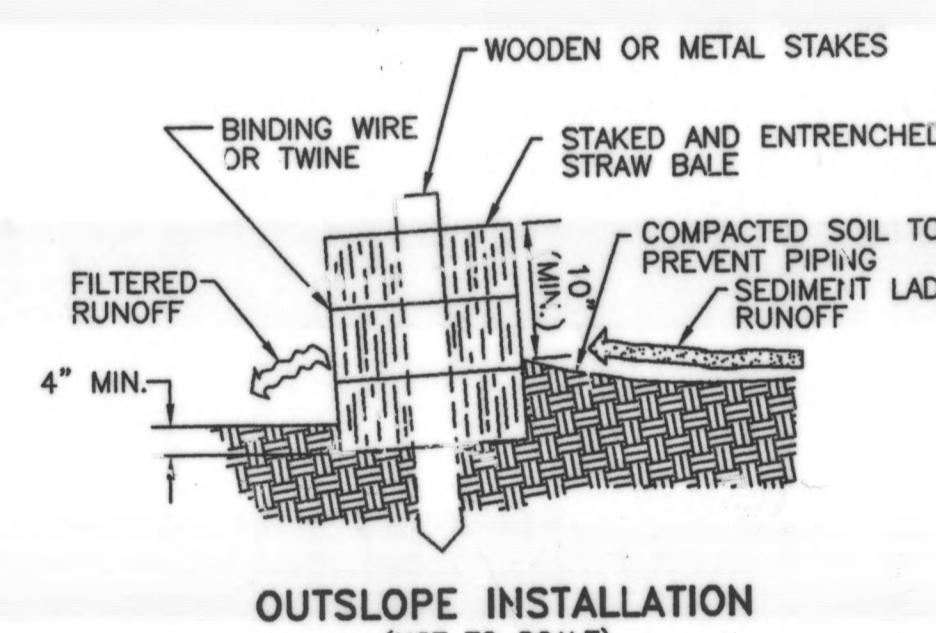

OUTSLOPE INSTALLATION
(NOT TO SCALE)

4 IP-4


CULVERT SCHEDULE

CULVERT	DIAMETER (IN)
PIPE 1	24"
PIPE 2	12"

5 IP-4

CATCH BASIN SCHEDULE


CATCH BASIN	ODOT TYPE
CB #1	ODOT 2-3 CATCH BASIN
CB #2	ODOT 2-3 CATCH BASIN

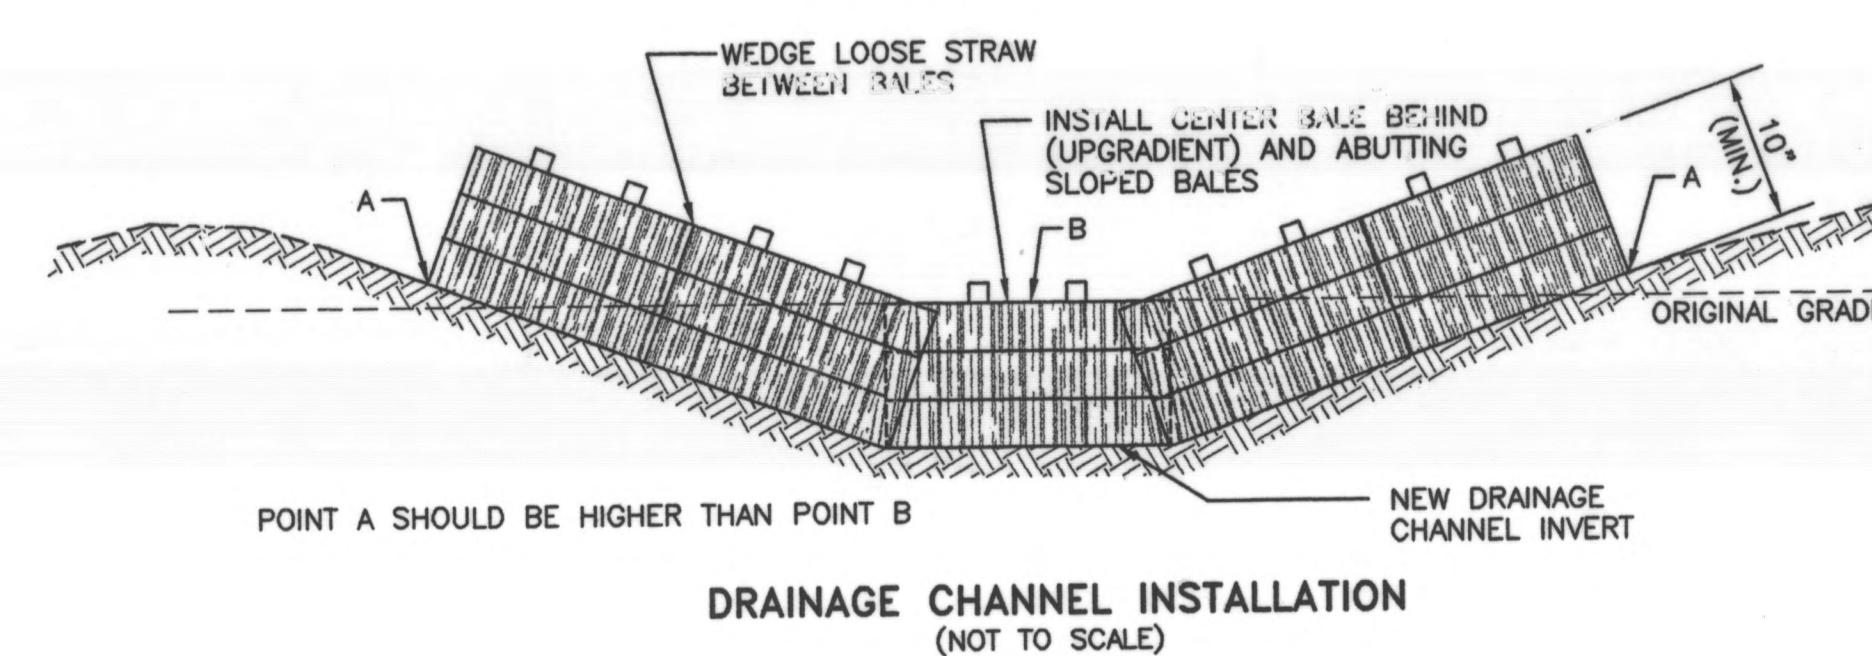

DRAINAGE CHANNEL INSTALLATION
(NOT TO SCALE)

6 IP-4

SEDIMENTATION TRAP DETAILS
(NOT TO SCALE)

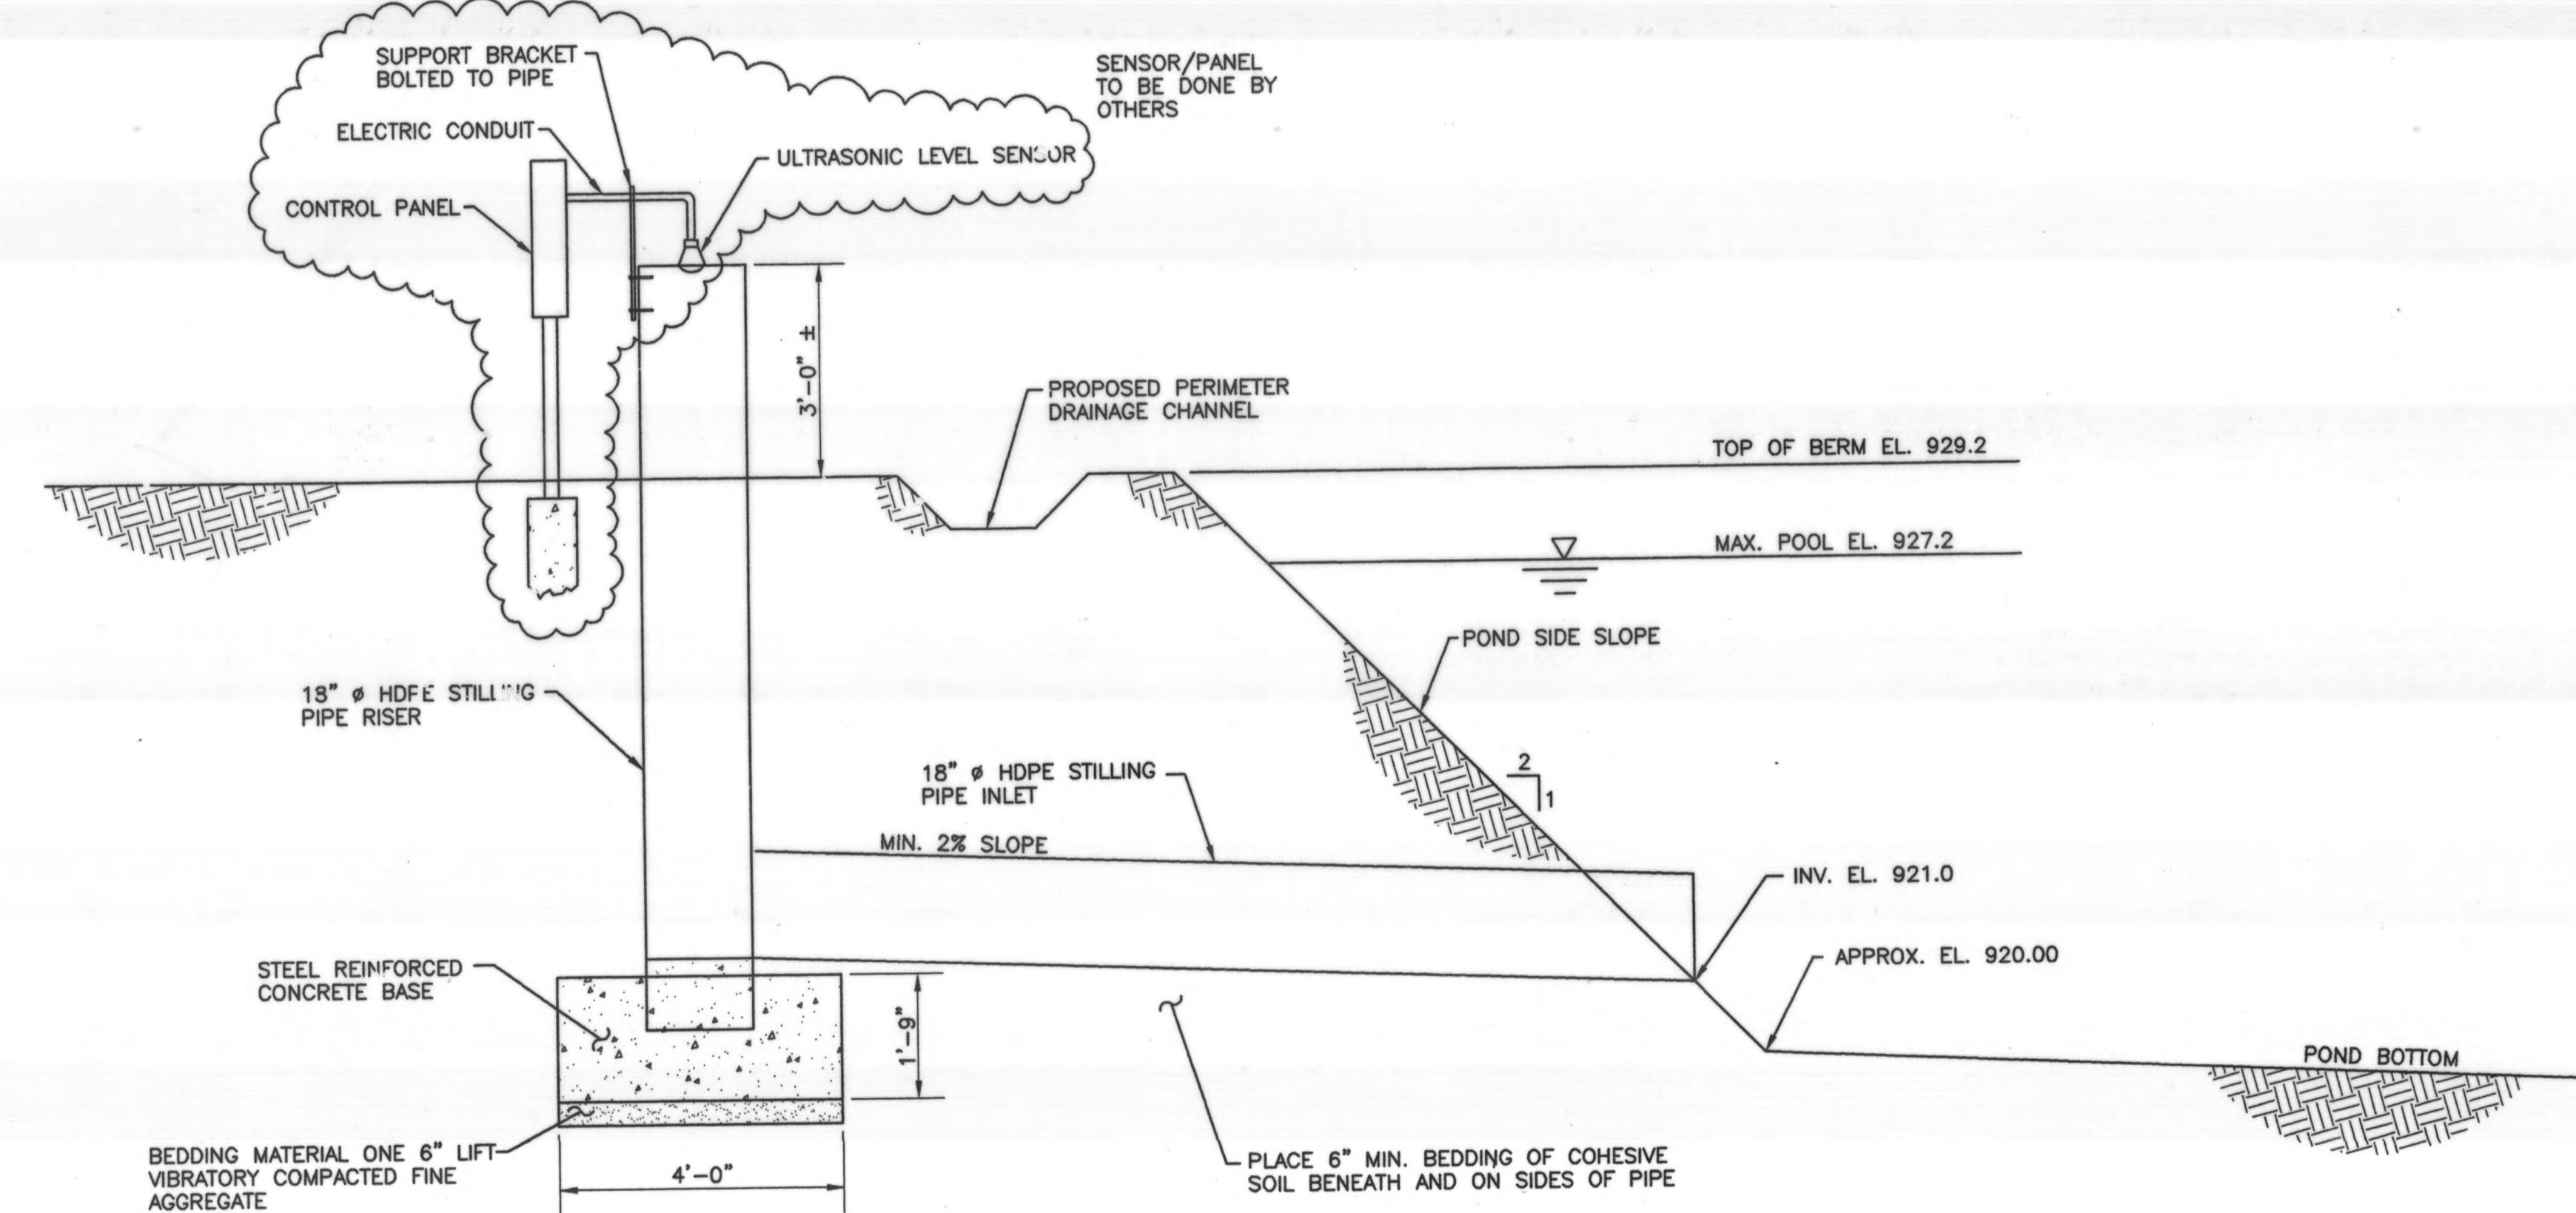

NOTE: CONCRETE TO BE POURED IN SUCH A MANNER TO INSURE THAT THE CONCRETE FILLS THE BOTTOM OF THE RISER TO THE INVERT OF THE INLET TO PREVENT THE RISER FROM BREAKING AWAY FROM BASE

7 IP-4

POOL LEVEL SENSING SYSTEM DETAIL
(NOT TO SCALE)

FIELD BOREHOLE LOG							BOREHOLE NUMBER: ZB-9			
PROJECT NUMBER RDZ 4363 EN PROJECT NAME: SCIOTO RESERVE IRRIGATION POND LOCATION: NW CORNER OF HOME & STEITZ ROADS, DELAWARE CO., OHIO DRILLING COMPANY: WRIGHTS DRILLING COMPANY, MT. STERLING, OHIO RIG TYPE & NUMBER: CENTRAL MINE EQUIPMENT CME-75 DRILLING METHOD: 4-1/4" I.D. w/2" I.D. ROCK CORING BIT WEATHER: 70 F, PARTLY SUNNY FIELD PARTY: BRIAN WRIGHT & JOE WRIGHT GEOLOGIST: NATE HULL & CHRIS KRUMM DATE BEGUN: 09/22/98 DATE COMPLETED: 09/23/98							FIELD BOOK NO.: ZB-9 TOTAL DEPTH: 30.0 GROUND SURFACE ELEVATION: 926.70 SHEET 1 OF 1			
DEPTH	SOIL SAMPLES	SAMPLING METHOD	SAMPLE NUMBER	MOISTURE	CONSISTENCY	BLOW COUNTS	LITHOLOGIC DESCRIPTION		LITHOLOGY	WELL INSTALLATION
							RECOVERY (IN)			
0.0				DY	NA	NA	NA	SILTY CLAY, brown, with fine-medium sand, trace fine gravel, dry		
5.0	AU	NA	DY	M	NA	NA	NA	SILTY CLAY, brown, little fine-medium sand content, no gravel, moist.		
10.0	AU	NA	M	M	NA	NA	NA			
15.0	AU	NA	M	M	NA	NA	NA	SILT, brown, with fine-medium sand and gravel, some clay, wet		
20.0	AU	NA	W	W	NA	NA	NA	SILTY CLAY, brown-gray, some fine-medium sand and gravel, shale fragments, wet		
25.0	AU	NA	W	W	NA	NA	NA	SHALE, dark gray, soft and friable, wet		
30.0	RC	NA	W	W	NA	NA	NA	LIMESTONE, gray, little fossil content, few fractures, competent bedrock, wet RDQ = 0.90		
							END OF BORING.			

TEST BORING LOG

PROJECT NAME Proposed Scioto Reserve Development - Home Rd. & 257, Delaware Co., OH BORING NO. ZB-
 CLIENT R.D. Zande & Associates, Inc. PROJ. NO. 7408-A SURF. ELEV. DATE DRILLED 8-12-

GROUND WATER OBSERVATION

12.0 FEET BELOW SURFACE AT COMPLETION
 FEET BELOW SURFACE AT 24 HOURS
 FEET BELOW SURFACE AT HOURS

LOCATION OF BORING			Proposed Detention Pond			
DEPTH	Sample Depths From To	Type of Sample	Blows per 6" on Sampler From To	Moisture Density or Consist.	Strata* Change Depth	SOIL IDENTIFICATION Remarks include color, type of soil, etc. Rock-color, type, condition, hardness
			0-6 6-12 12-18			
0	0.0-2.0	D	3 5 5	Moist	0.6	TOPSOIL Brown CLAY-SILT, Little F-C Sand, Trace Gravel (Glacial TILL with Sand and Gravel Layers and Cobbles)
			6			
2	2.0-4.0	D	8 8 9	Moist	8.5	SHELBY TUBE SAMPLE FROM 8.0'-10.0' Gray CLAY-SILT, Some F-C Sand, Little Gravel (Glacial TILL)
			9			
4	4.0-6.0	D	6 6 6	Moist	10	
			7			
6	6.0-8.0	D	4 5 5	Moist	12.0-14.0	
			6			
8	8.0-10.0	U		Moist	14.0-16.0	
10	10.0-12.0	D	8 8 9	Moist	15.0	
			9			
12	12.0-14.0	D	8 7 7	Moist	16.0	
			10			
14	14.0-16.0	U				
						BOTTOM OF BORING: 16.0'

FIELD BOREHOLE LOG							BOREHOLE NUMBER: ZB-10		
PROJECT NUMBER: RDZ 1363 EN PROJECT NAME: SCIOTO RESERVE IRRIGATION POND LOCATION: NW CORNER OF HOME & STEITZ ROADS, DELAWARE CO., OHIO GROUND SURFACE ELEVATION: 926.50 DRILLING COMPANY: WRIGHTS DRILLING COMPANY, MT. STERLING, OHIO SHEET 1 OF 1 RIG TYPE & NUMBER: CENTRAL MINE EQUIPMENT CME-75 DRILLING METHOD: 4-1/4" I.D. x 2" I.D. ROCK CORING BIT WEATHER: 70 F, PARTLY SUNNY FIELD PARTY: BRIAN WRIGHT & JOE WRIGHT GEOLOGIST: NATE HULL & CHRIS KRAMM DATE BEGUN: 09/23/98 DATE COMPLETED: 09/23/98							FIELD BOOK NO.: ZB-10 TOTAL DEPTH 26.0 STATIC WATER LEVEL (FBS) WD=While Drilling AB=After Boring Depth (ft) 20.0' 40' Time 1600 Date 09/23/98		
DEPTH	SOIL SAMPLES	SAMPLING METHOD	SAMPLE NUMBER	MOISTURE	CONSISTENCY	BLOW COUNTS (IN)	LITHOLOGIC DESCRIPTION	LITHOLOGY	WELL INSTALLATION
0.0	AU	NA	DY	NA	NA	NA	SILTY CLAY, brown, with fine-medium sand, trace fine gravel, dry.		
5.0			DY	NA	NA	NA	SANDY SILT, brown, glacial till, some clay, little fine gravel, moist.		
10.0	AU	NA	M	NA	NA	NA			
15.0			M	NA	NA	NA			
20.0	AU	NA	W	NA	NA	NA	SHALE, dark gray, soft and friable, wet.		
25.0	RC	NA	W	NA	NA	NA	LIMESTONE, gray, little fossil content, interbedded with shale, highly fractured, wet RDQ = 0.12		
END OF BORING									

Proportions Used		140 lb Wt. x 30" fall on 2" O.D. Sampler			
		Cohesionless Density		Cohesive Consistency	
trace	0 to 10%	0 - 10	Loose	0 - 4	Soft
little	10 to 20%	10 - 30	Medium Dense	4 - 8	Medium Stiff
some	20 to 35%	30 - 50	Dense	8 - 15	Stiff
and	35 to 50%	50 +	Very Dense	15 - 30	Very Stiff
				30 +	Hard






$$RQD = \frac{\sum \text{LENGTHS OF INTACT PIECES OF CORE} > 100\text{mm}}{\text{LENGTH OF CORE ADVANCE}}$$


ROCK QUALITY DESIGNATION	
RQD	ROCK DESCRIPTION
< 0.25	VERY POOR
0.25 - 0.50	POOR
0.50 - 0.75	FAIR
0.75 - 0.90	GOOD
> 0.90	EXCELLENT

ROCK DESCRIPTIVE TERMS		
JOINT SPACING	BEDDING THICKNESS	JOINT SPACING
VERY CLOSE	VERY THIN	< 2"
CLOSE	THIN	2" - 1'
MODERATELY CLOSE	MEDIUM	1' - 3'
WIDE	THICK	3' - 10'
VERY WIDE	VERY THICK	> 10'

PROJECT NAME	Proposed Scioto Reserve Development - Home Rd. & 257, Delaware Co., OH								BORING NO.	ZB-			
CLIENT	R.D. Zande & Associates, Inc.								PROJ. NO.	7408-A			
GROUND WATER OBSERVATION										SURF. ELEV.			
<u>None</u> FEET BELOW SURFACE AT COMPLETION										DATE DRILLED			
<u> </u> FEET BELOW SURFACE AT 24 HOURS										8-12			
<u> </u> FEET BELOW SURFACE AT <u> </u> HOURS													
LOCATION OF BORING				Proposed Detention Pond									
DEPTH	Sample Depths From To	Type of Sample	Blows per 6" on Sampler			Moisture Density or Consist.	Strata* Change Depth	SOIL IDENTIFICATION					
			From	To	0-6			6-12	12-18	Remarks include color, type of soil, etc. Rock-c 'or, type, condition, hardness			
5	0.0-2.0	D	3	4	5	Moist	0.7	TOPSOIL Brown CLAY-SILT, Little F-C Sand, Trace Gravel (Glacial TILL)					
			6										
		2.0-4.0	D	3	3		3						
				4									
		4.0-6.0	D	3	5		6						
				8									
		6.0-8.0	D	7	7		9						
				11									
10	8.0-10.0		5	6	6	Moist							
			6										
		10.0-12.0	D	5	6		9						
				10									
		12.0-14.0	U										
		14.0-16.0	D	6	9		9						
				9									
15	16.0-17.5	D	6	15	22	Moist							
		18.0-20.0	D	6	9		9						
				10									
BOTTOM OF BORING: 20.0'													
Black SHALE Encountered at Bottom of Boring (20.0')													


R.D.Zande & Associates		DESIGNED BY: DRAWN BY: CHECKED BY: APPROVED BY: DATE: JOB NO.	TAM MDK TAM JFS JANUARY 25, 1999 4363EN	REVISIONS REMARKS	IRRIGATION POND DELAWARE COUNTY SCIOTO RESERVE IRRIGATION POND BORING LOGS AND SOIL LABORATORY RESULTS	SCALE: DATE NOT TO SCALE	SHEET NO. IP-5
 <p>STATE OF OHIO PATRICK E. BLAYNEY E31768 REGISTERED PROFESSIONAL ENGINEER</p>							

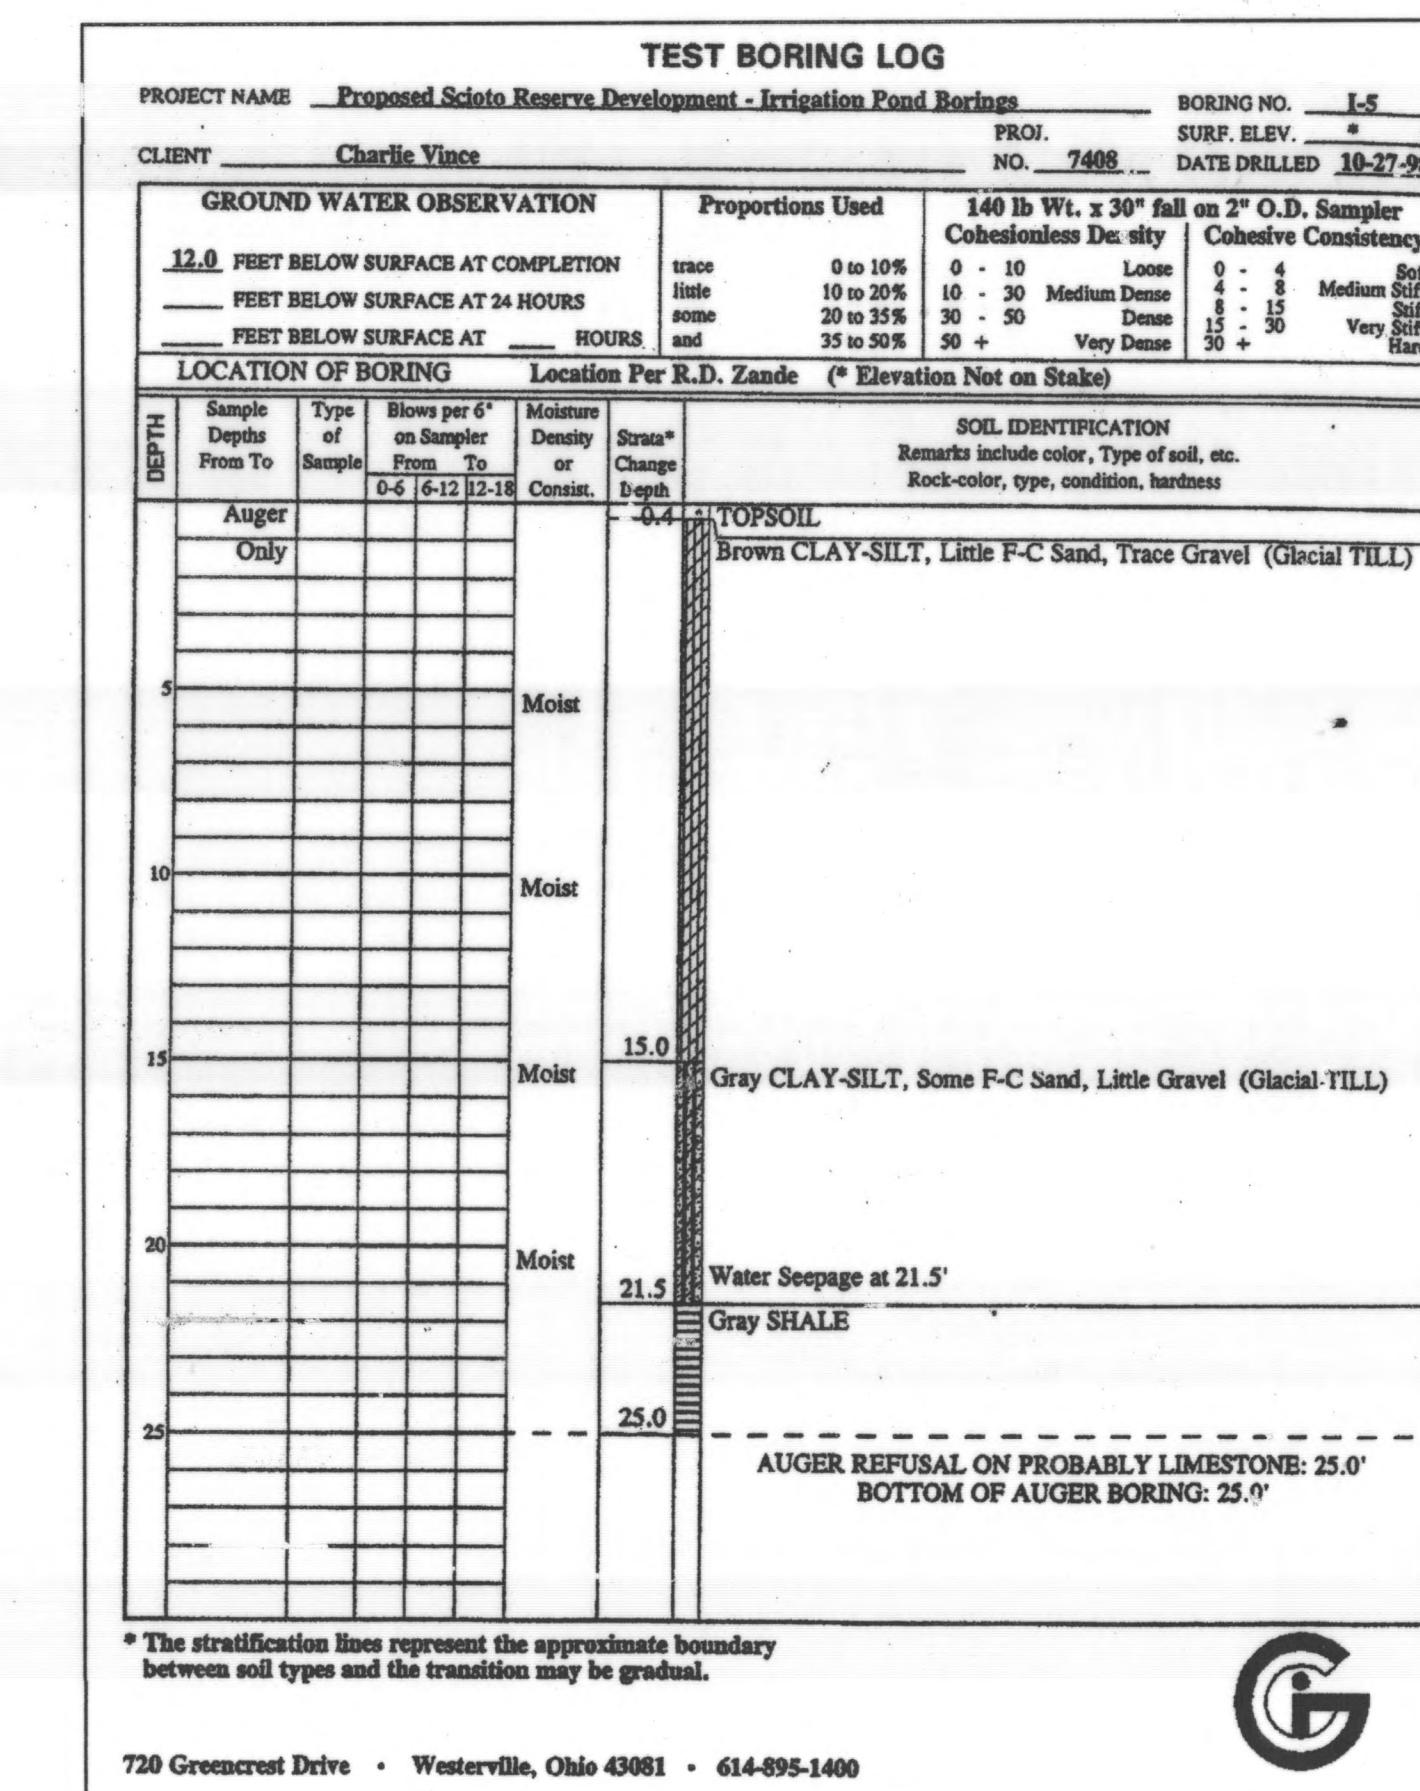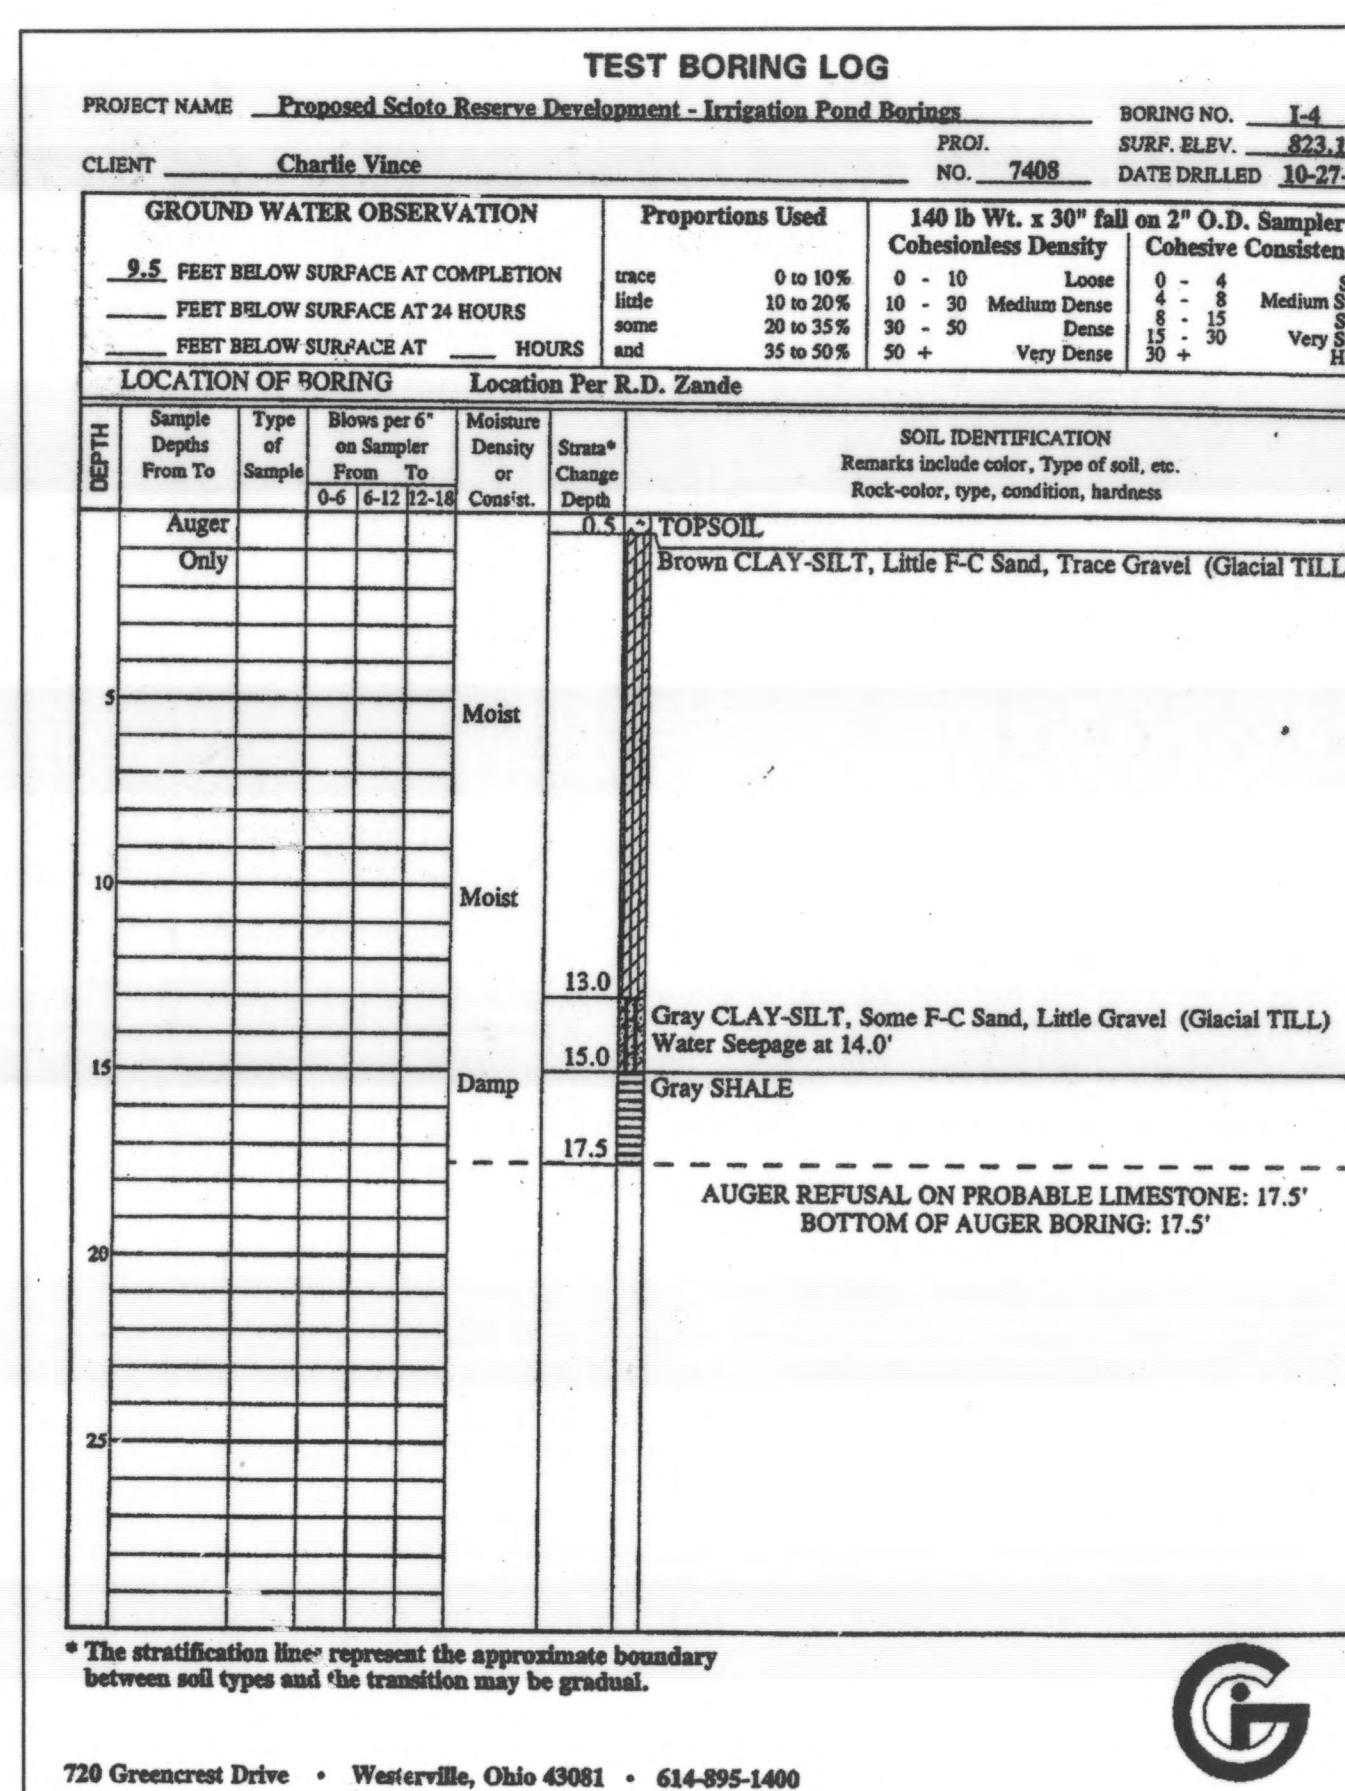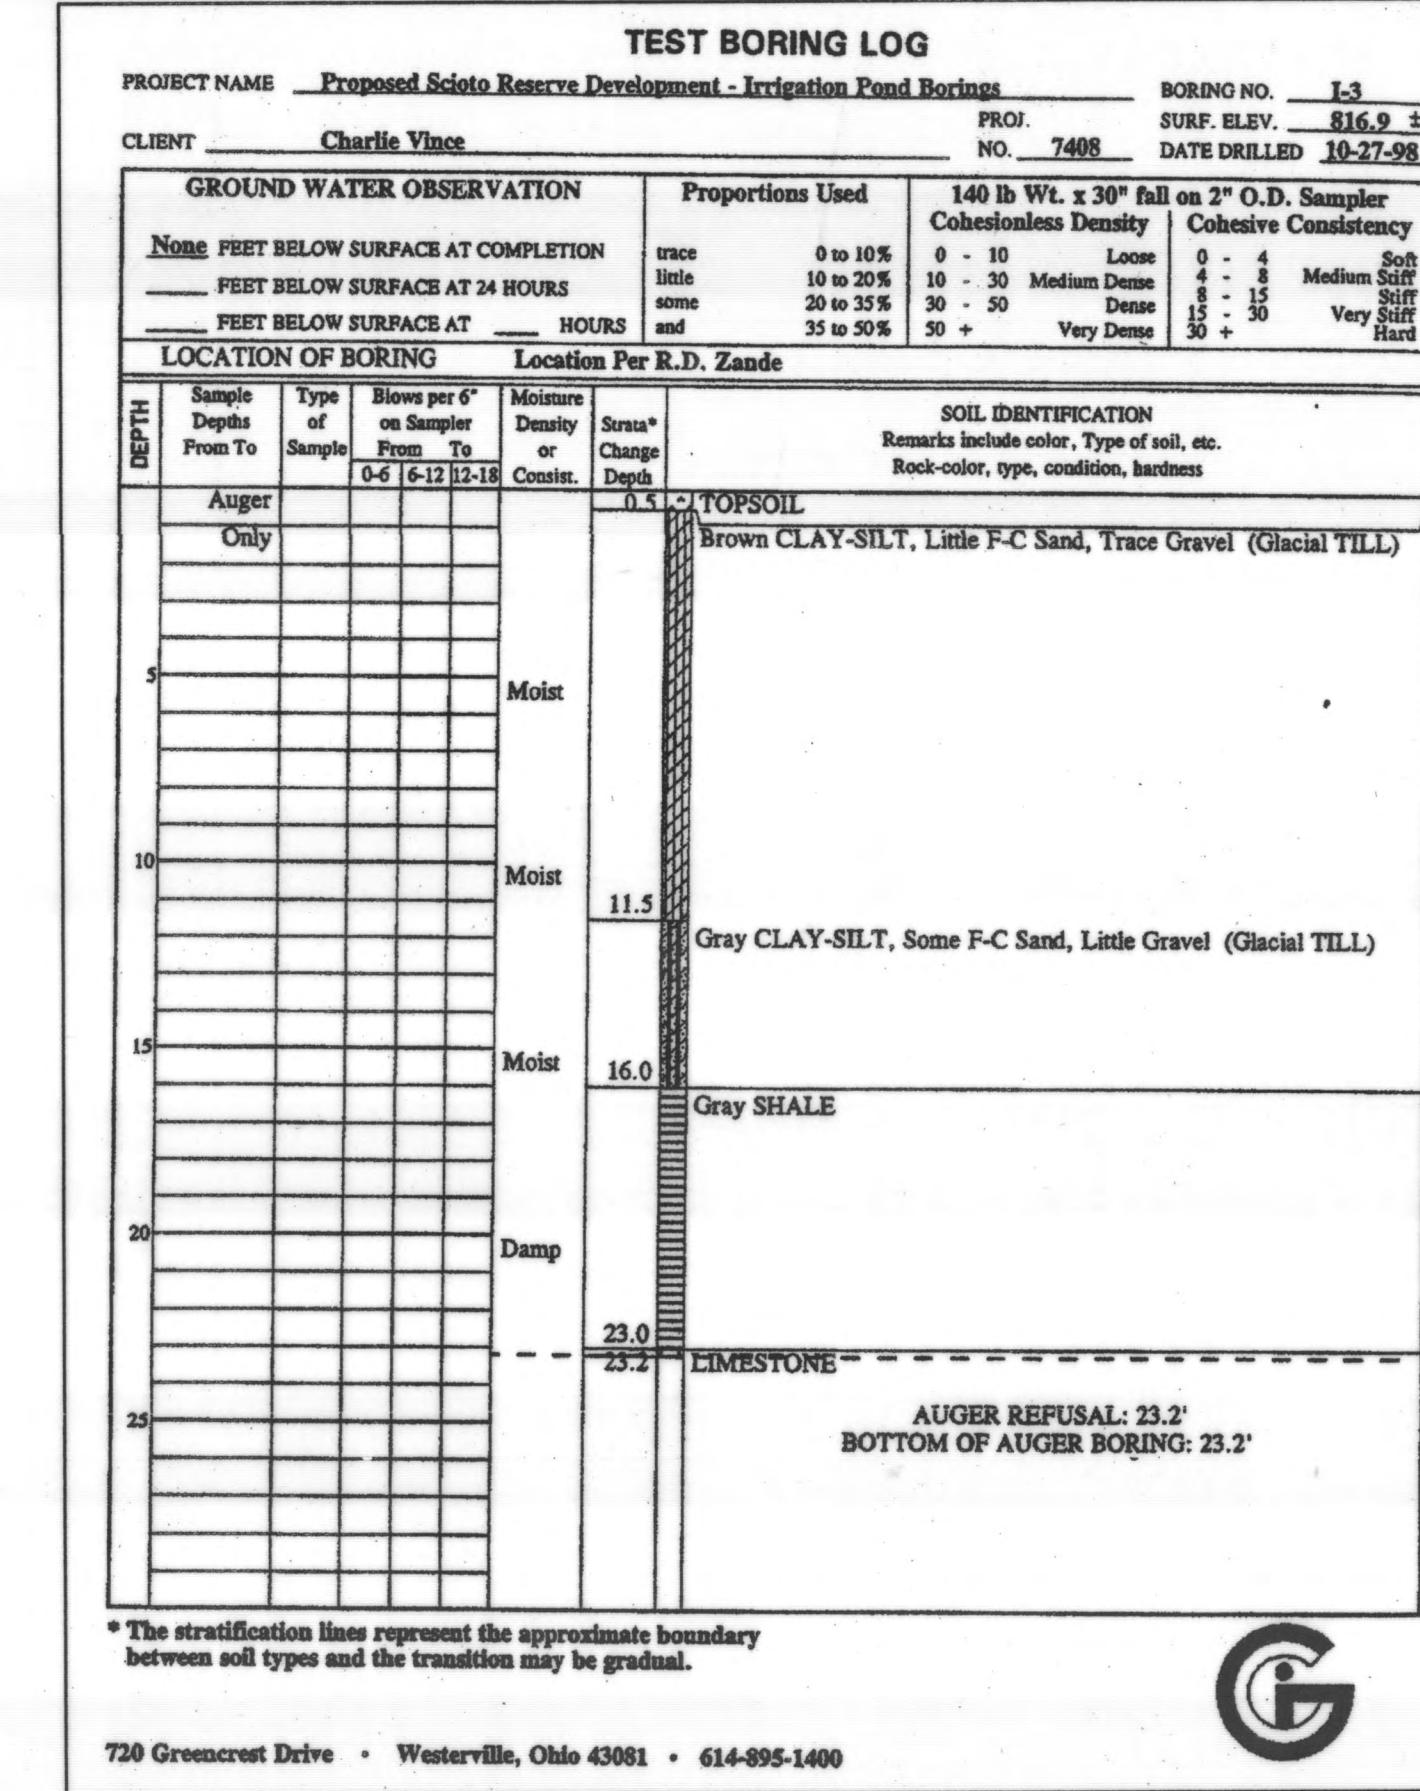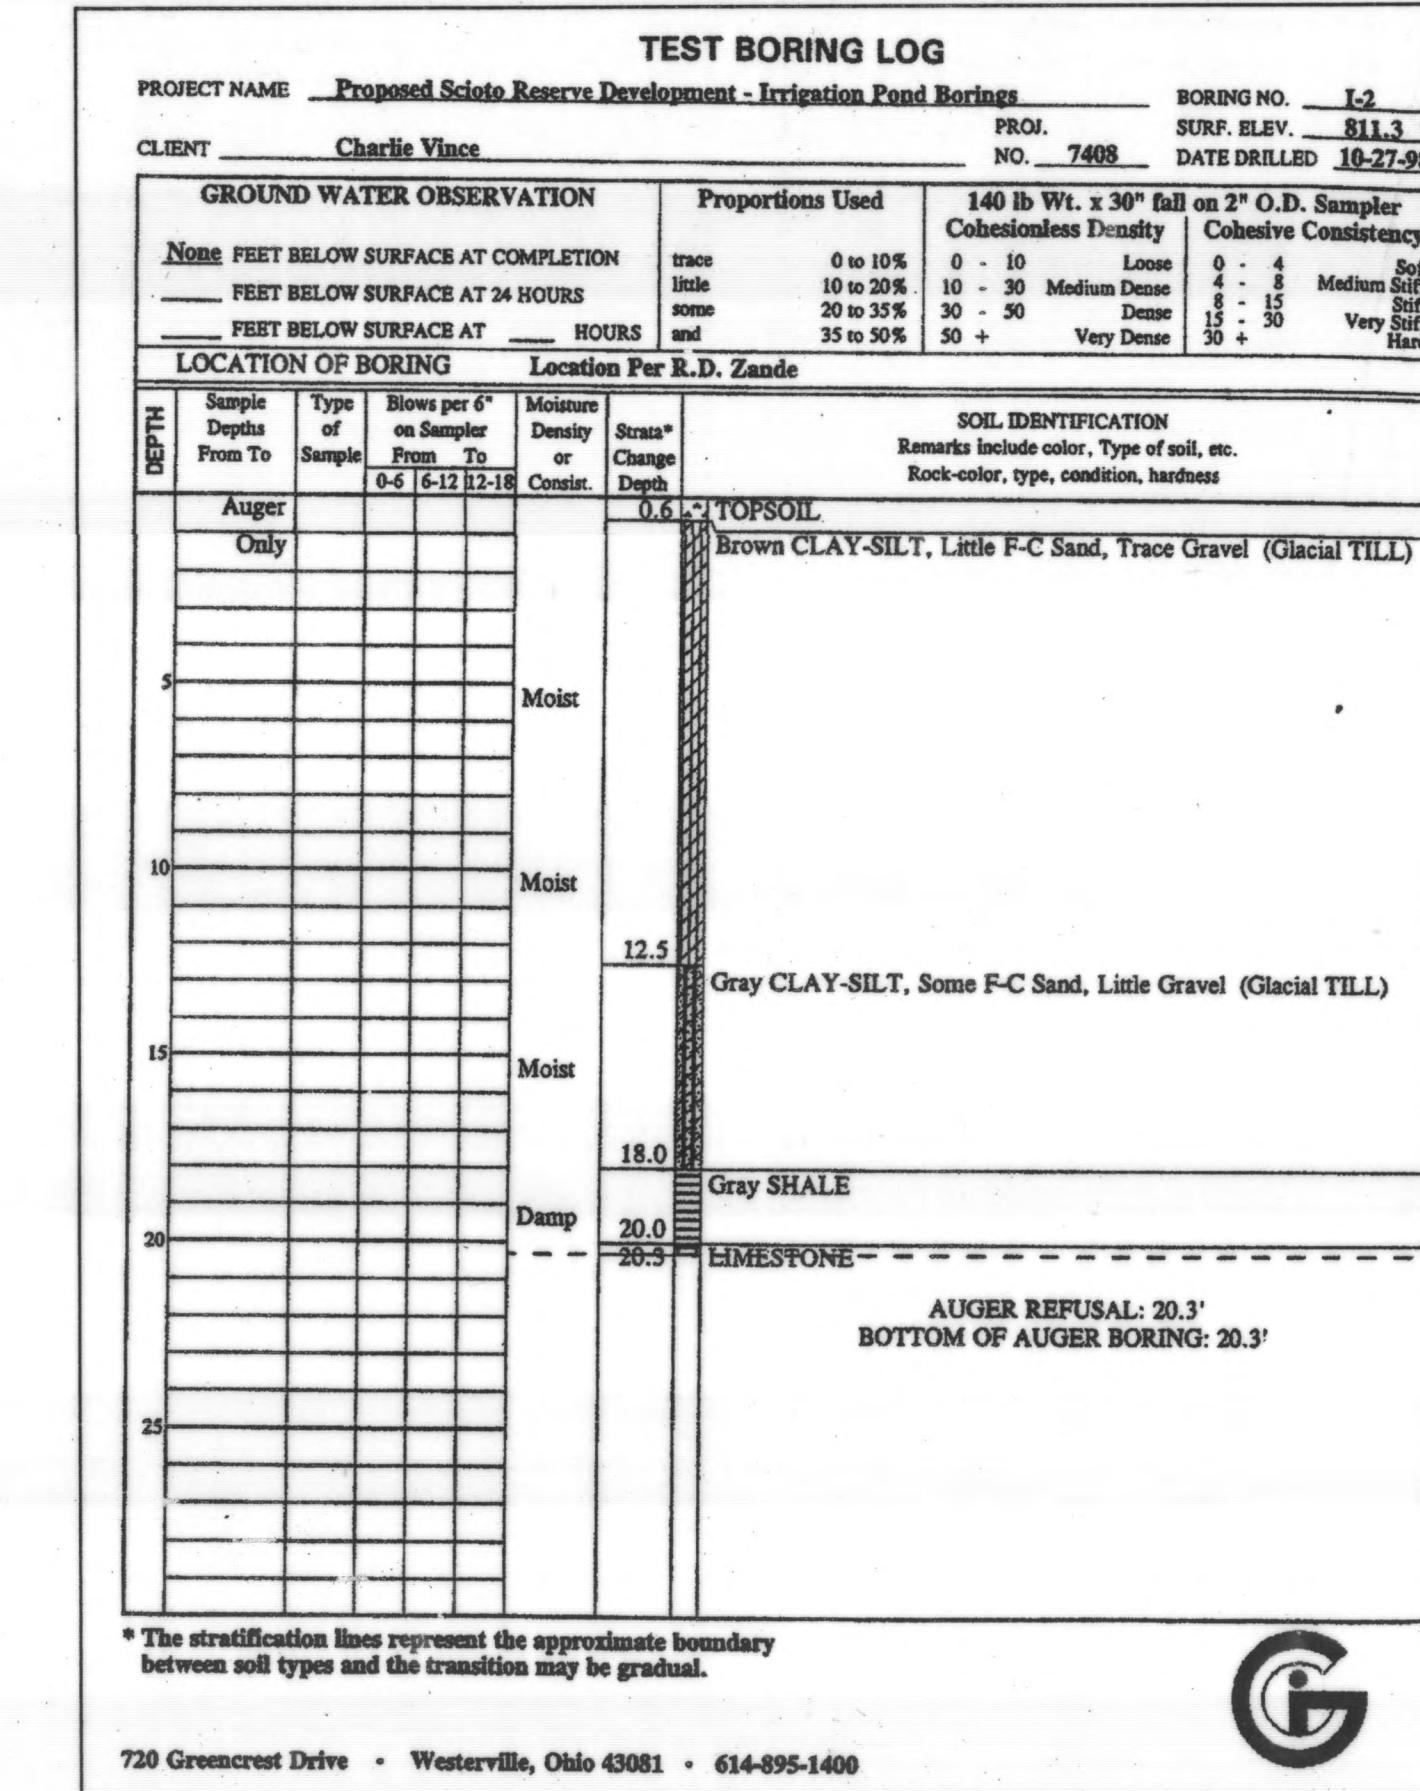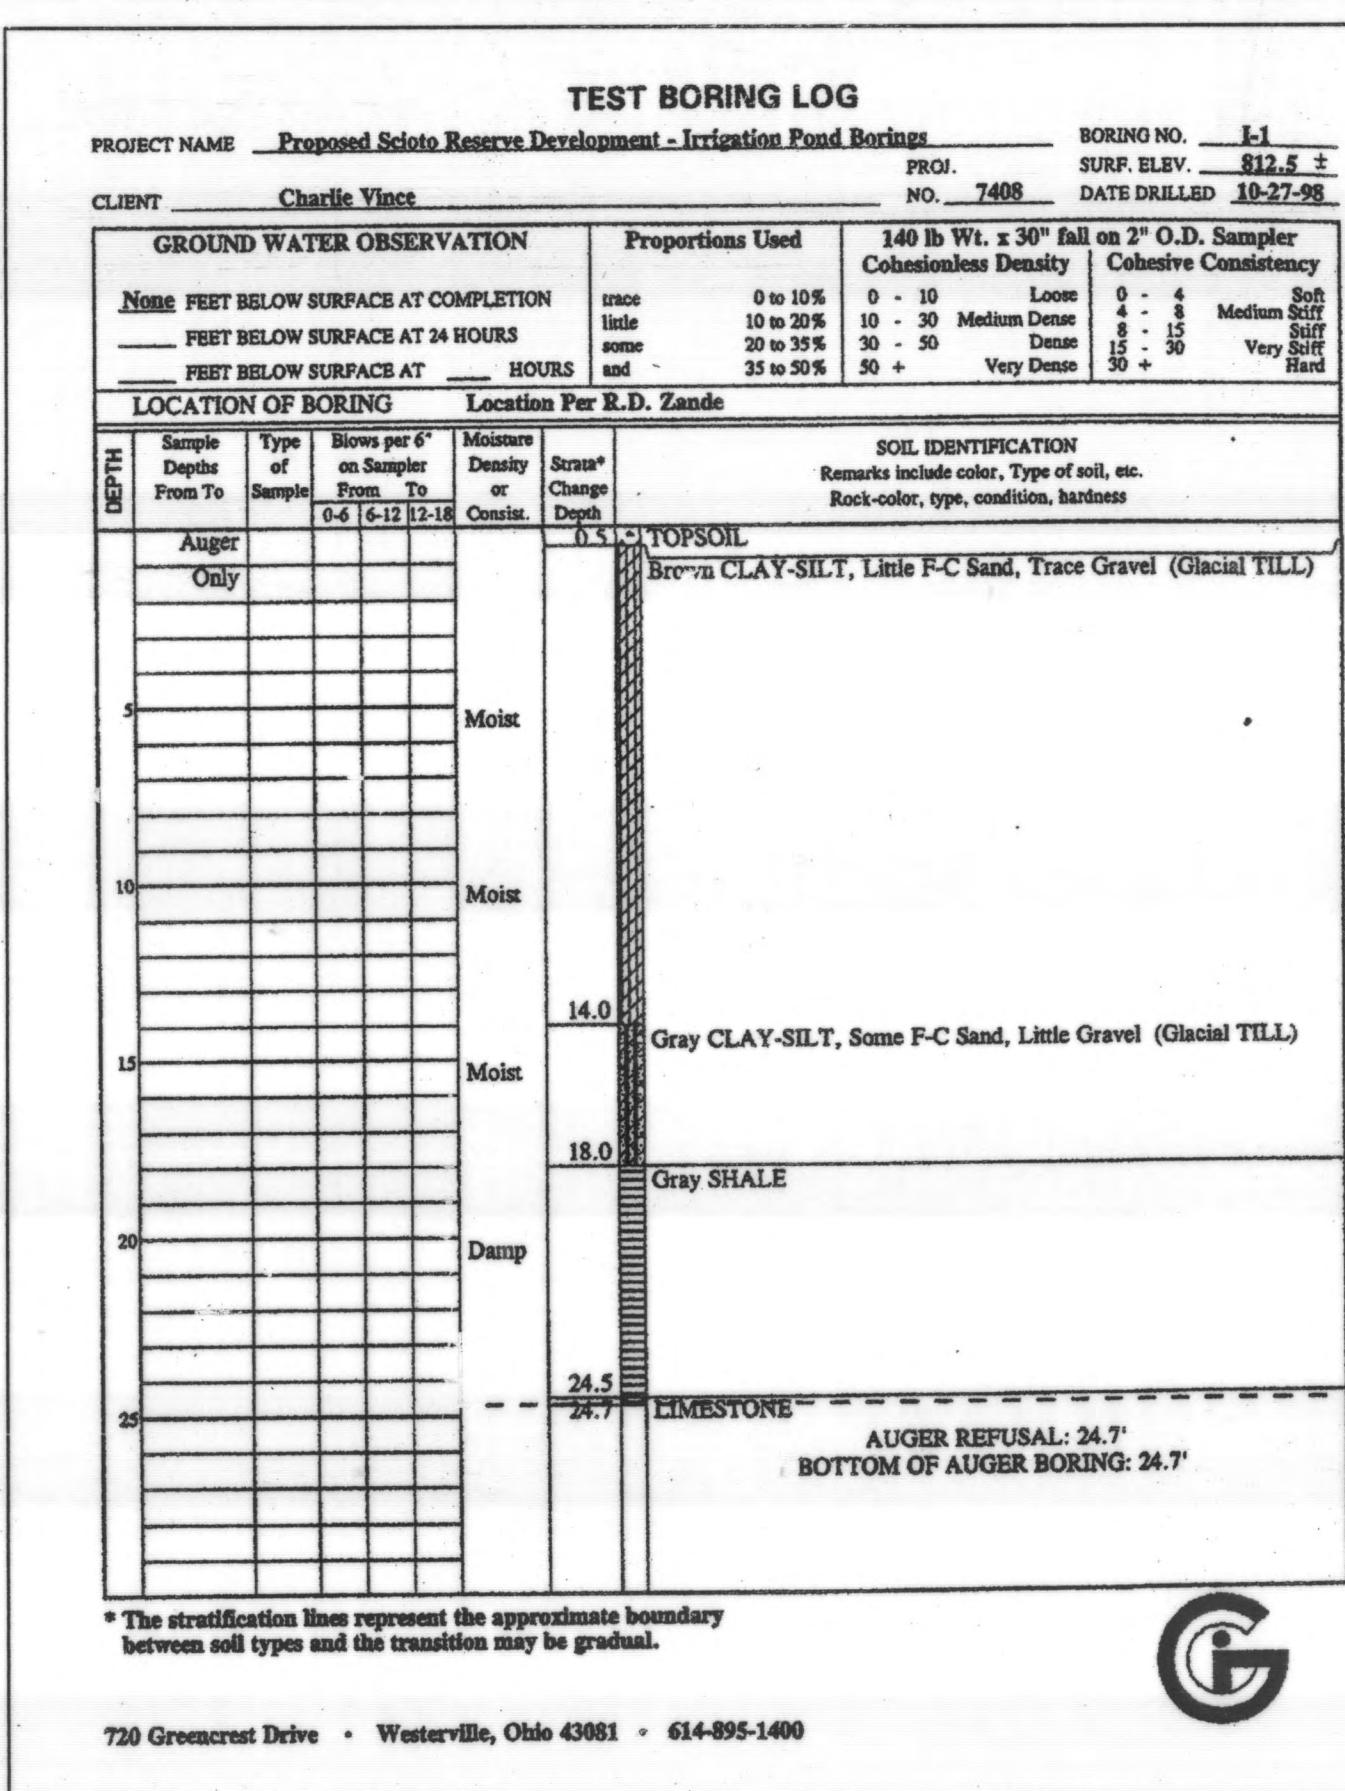

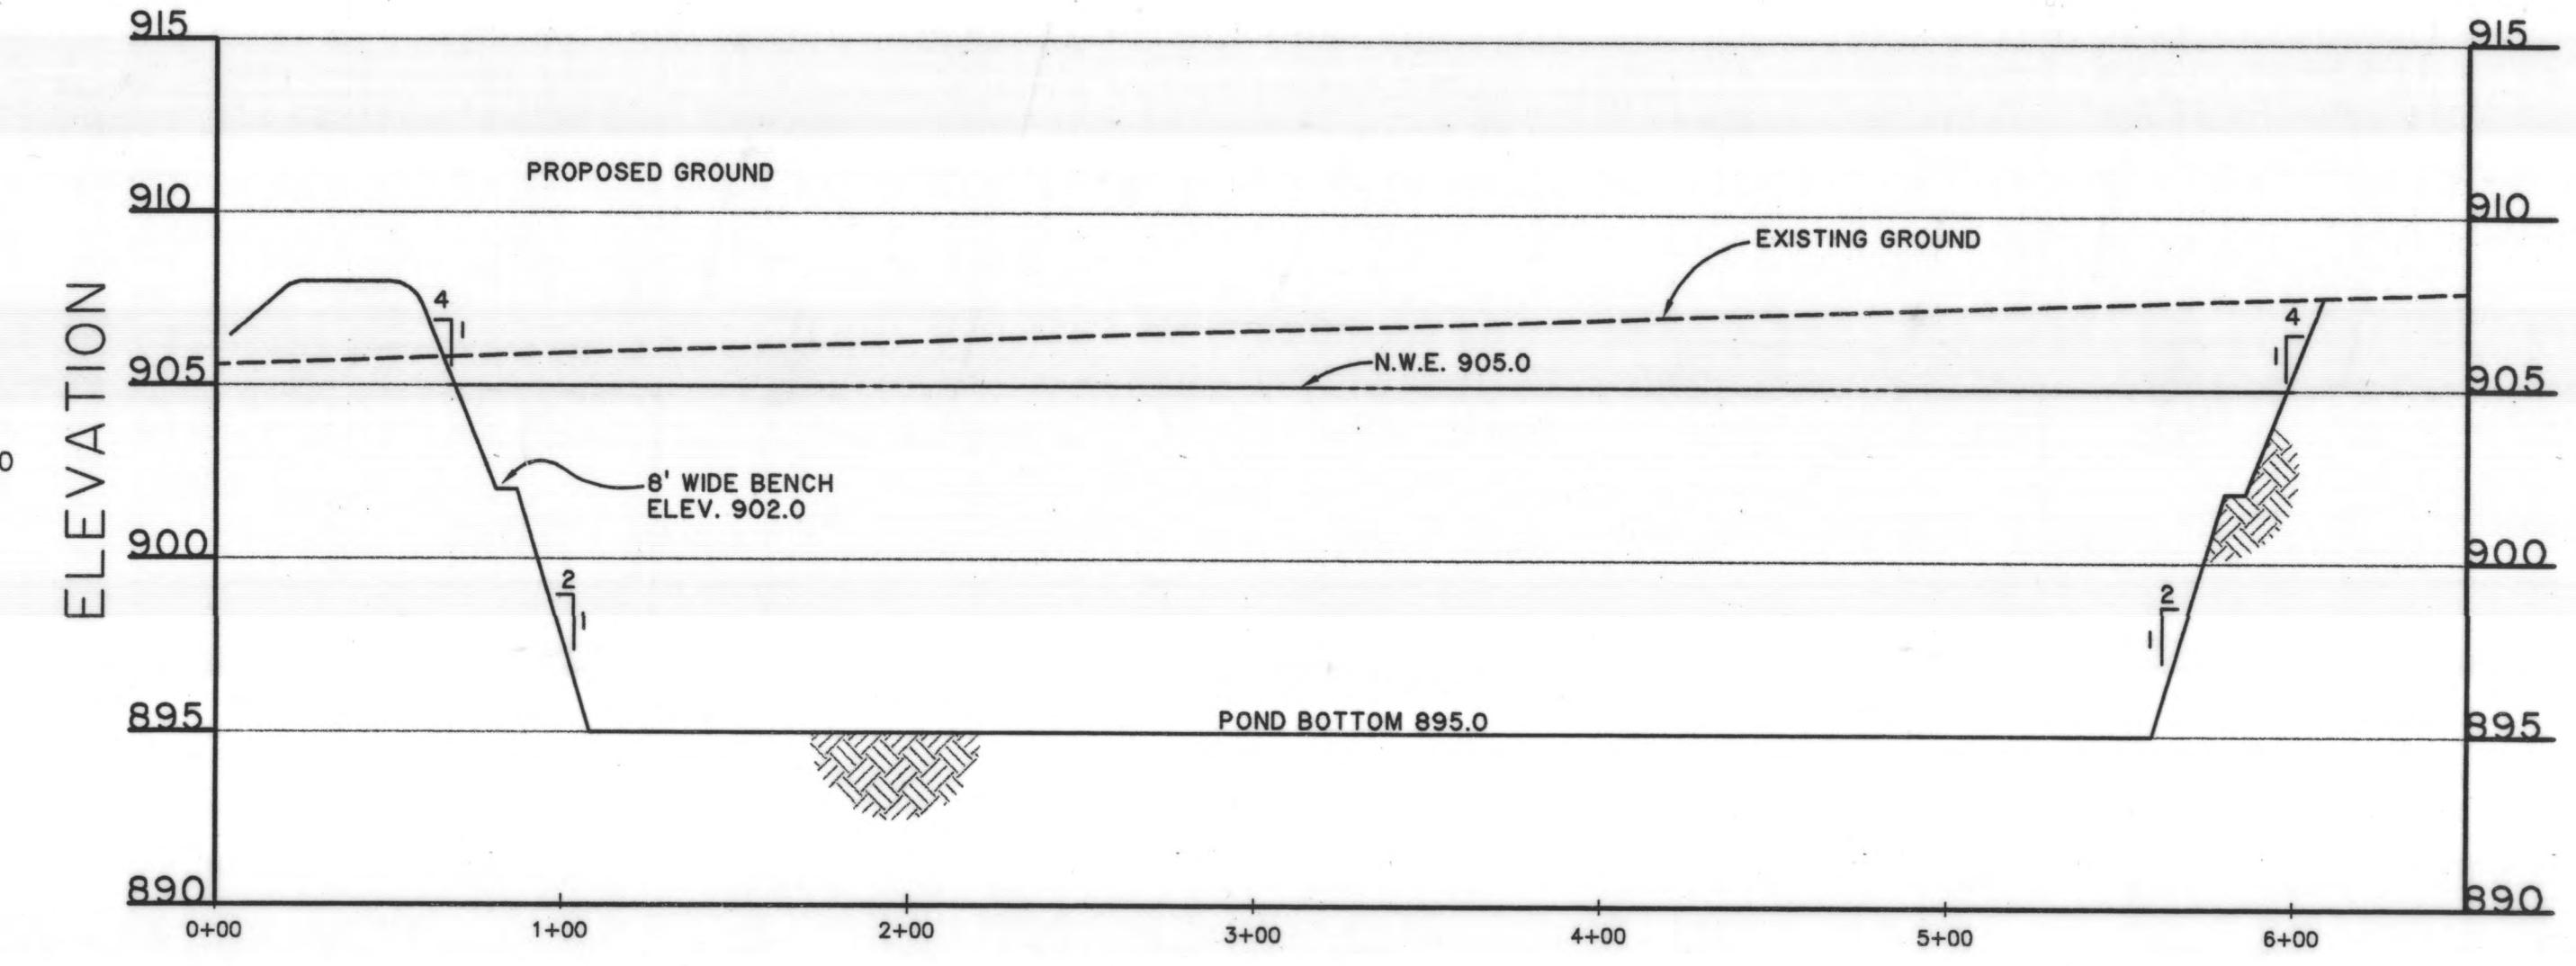

POND CROSS SECTION A-A
(LOOKING NORTHWEST)


(LOOKING NORTHW


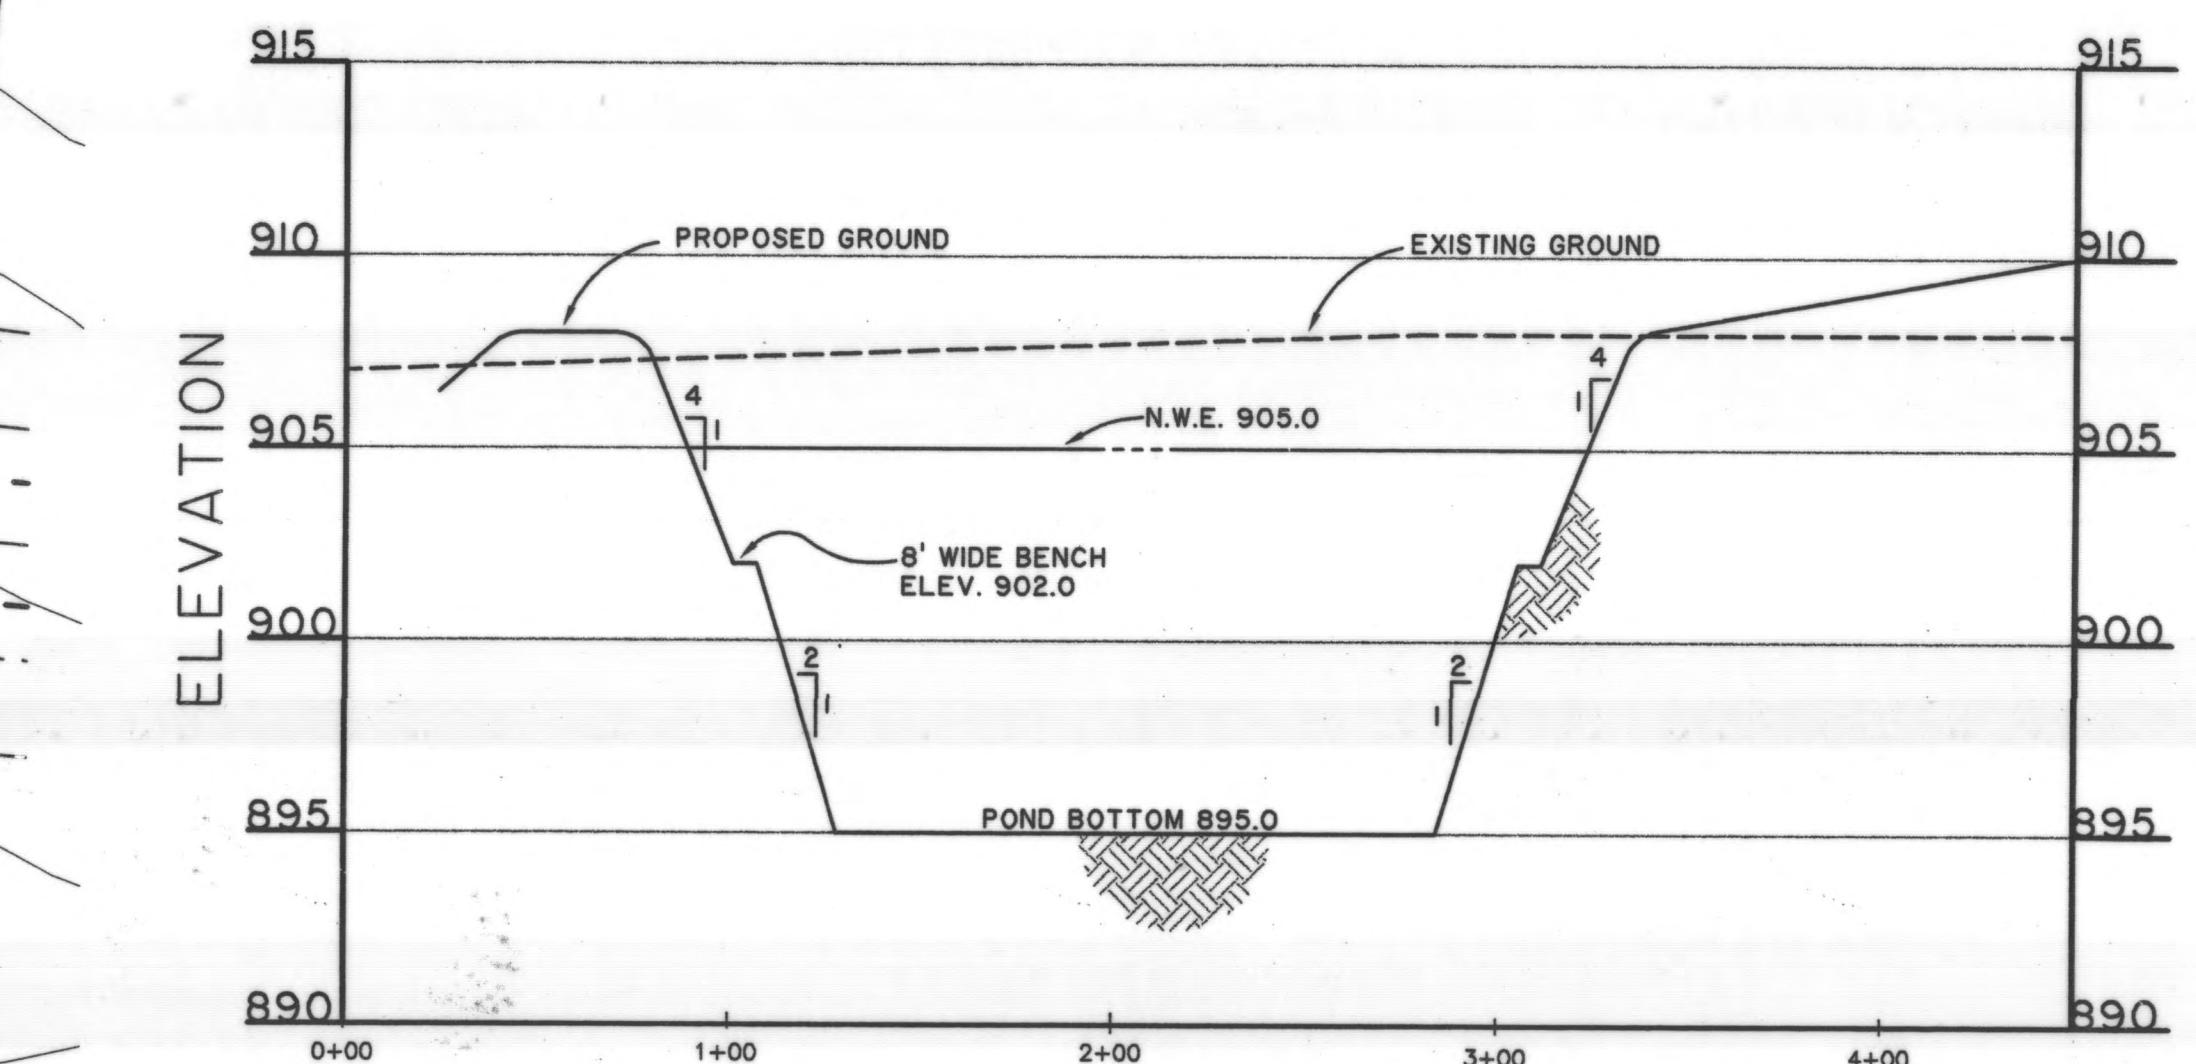


POND CROSS SECTION B-B
(LOOKING SOUTHWEST)

(LOOKING SOUTHWEST)

STAGE STORAGE (HOLE 9)				
ELEVATION (FT.)	AREA (SQ. FT.)	ACCUMULATIVE DEPTH (FT.)	VOLUME (CU. FT.)	CUMULATIVE (ACRES FT.)
895.0	51900	7	460600	10.57
902.0	79700	8	82625	12.17
903.0	85550	9	88525	14.50
904.0	91500	10	94550	16.67
905.0	97600	11	100800	18.99
906.0	104000	12	107000	21.44
907.0	110000			

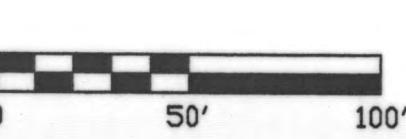

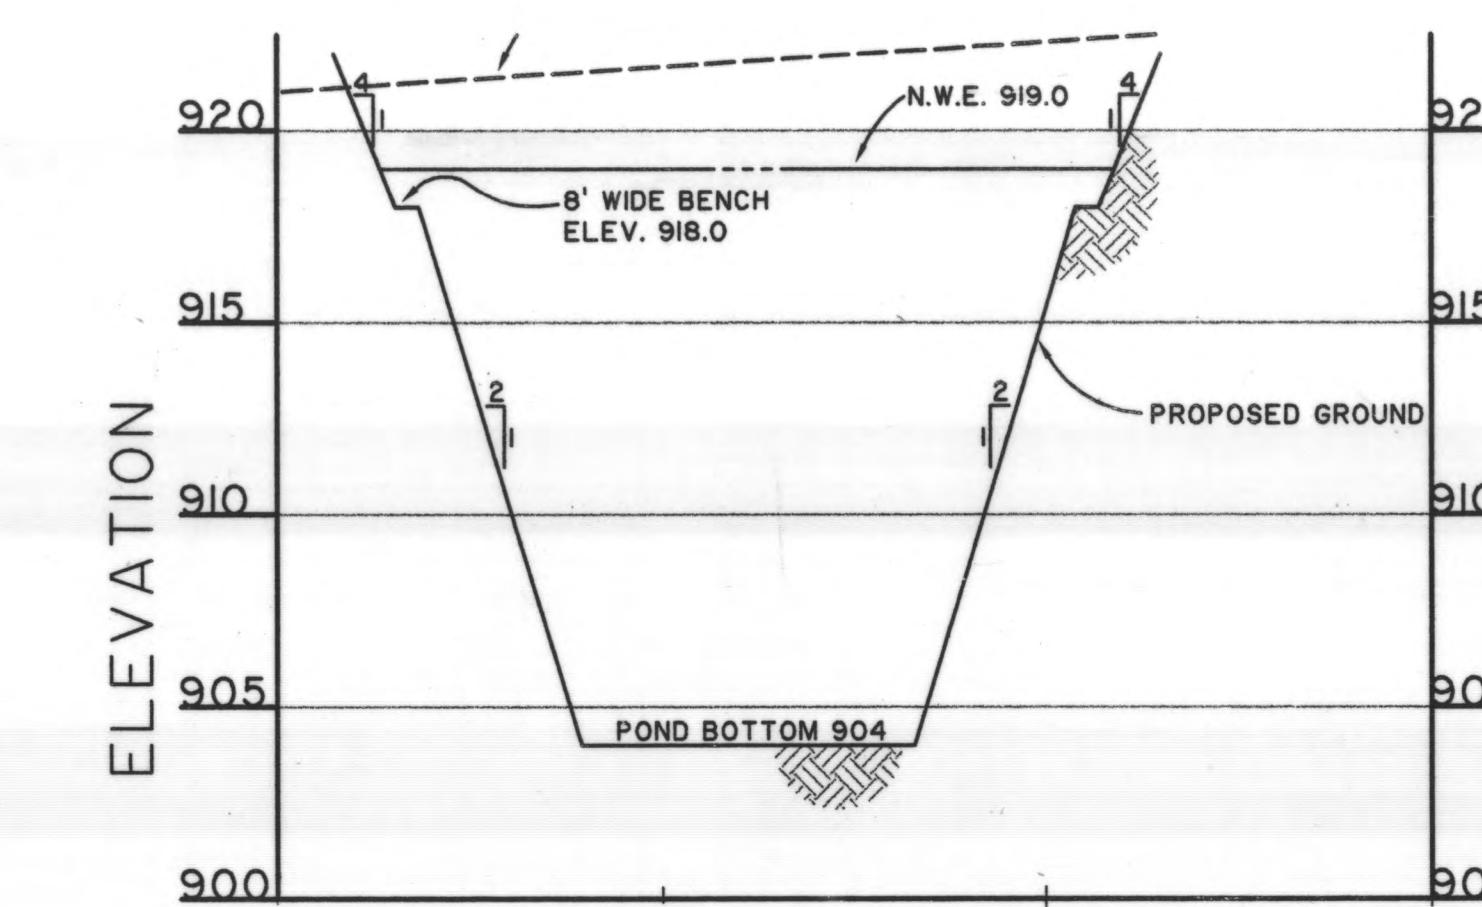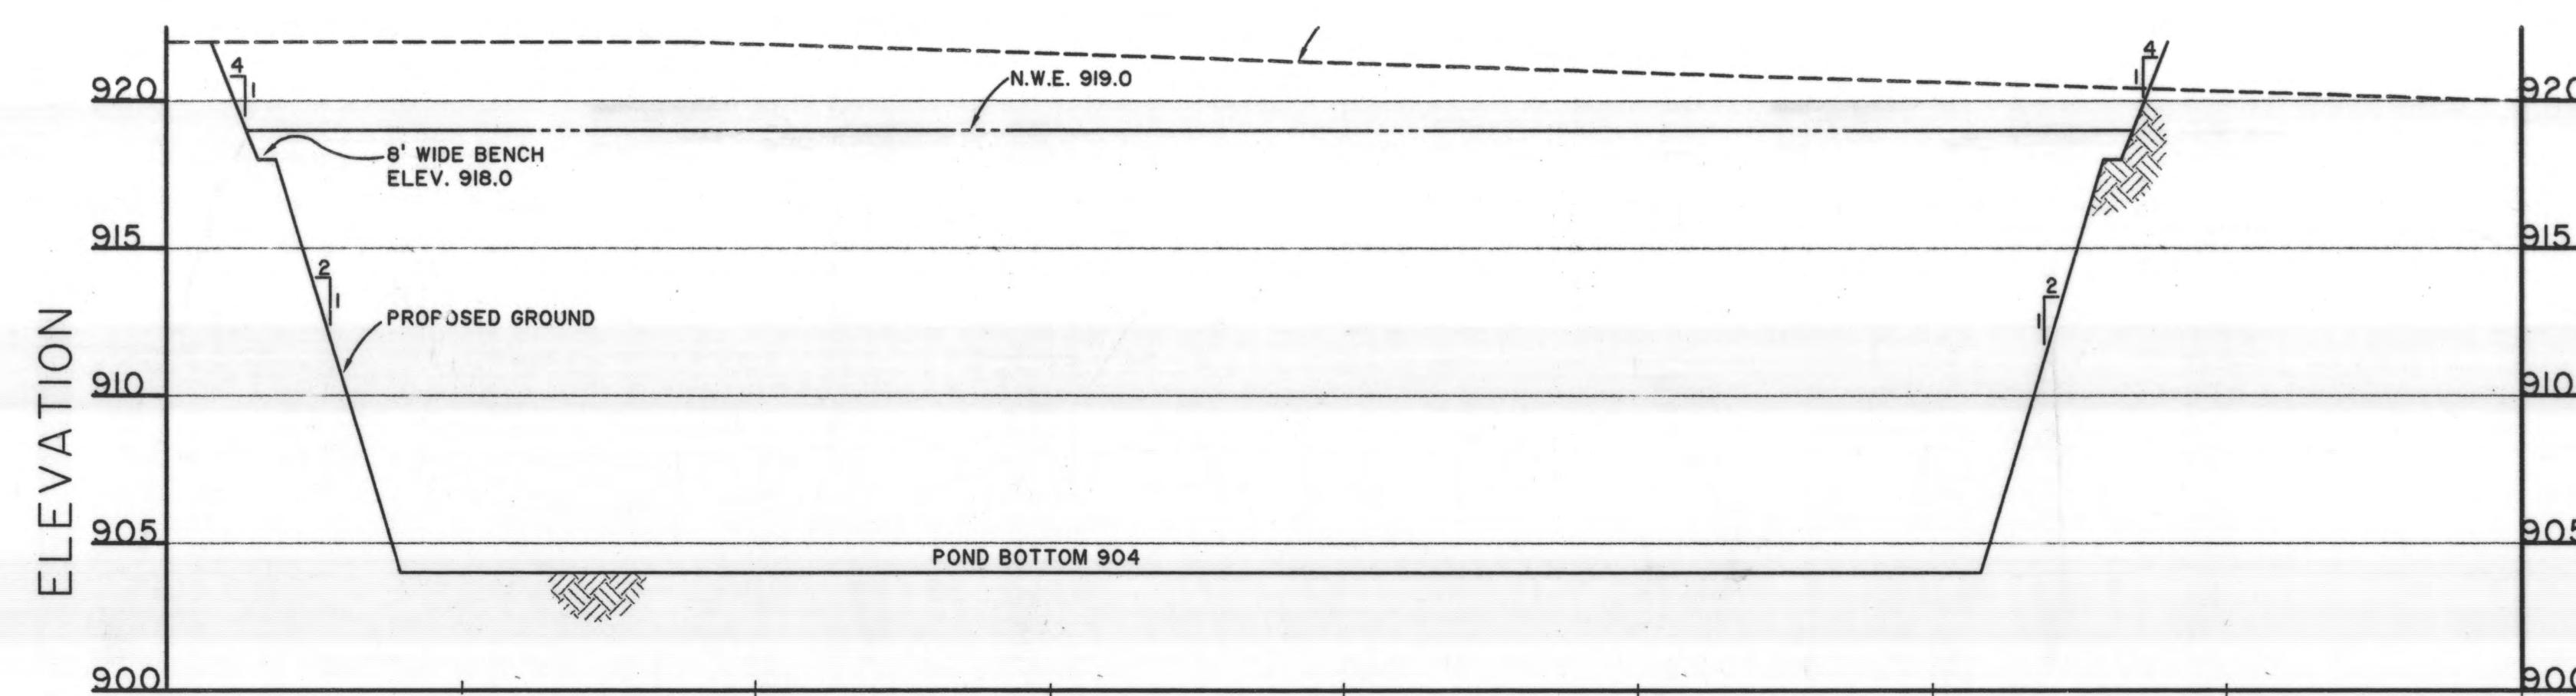

LEGEND



- PROPOSED FORCE MAIN
- PROPERTY LINE
- EXISTING CONTOUR WITH ELEVATION
- PROPOSED SLOPE INDICATOR
- PROPOSED CONTOUR WITH ELEVATION
- MAXIMUM POOL ELEVATION
- PROPOSED SPOT ELEVATION

NOTES:

- THE CONTRACTOR SHALL IMMEDIATELY NOTIFY THE ENGINEER IF ANY SPRINGS OR SEEPs ARE ENCOUNTERED WITHIN THE SUBGRADE AREA.
- BOUNDARY AND TOPOGRAPHIC MAPPING IS BASED ON THE DELAWARE COUNTY GIS SYSTEM FIELD VERIFIED SURVEY, BY R.D. ZANDE & ASSOCIATES, INC. IN JULY AND AUGUST 1999. THE BEARINGS SHOWN ARE BASED ON THE GRID BEARING OF N 86°28'32" W BETWEEN DELAWARE COUNTY GIS MONUMENTS, DEL94 AND DEL89, DETERMINED BY A GPS NETWORK OF FIELD OBSERVATIONS PERFORMED IN JULY, 1999.

POND 15 CROSS SECTION A-A
(LOOKING NORTH)

POND 15 CROSS SECTION B-B
(LOOKING WEST)

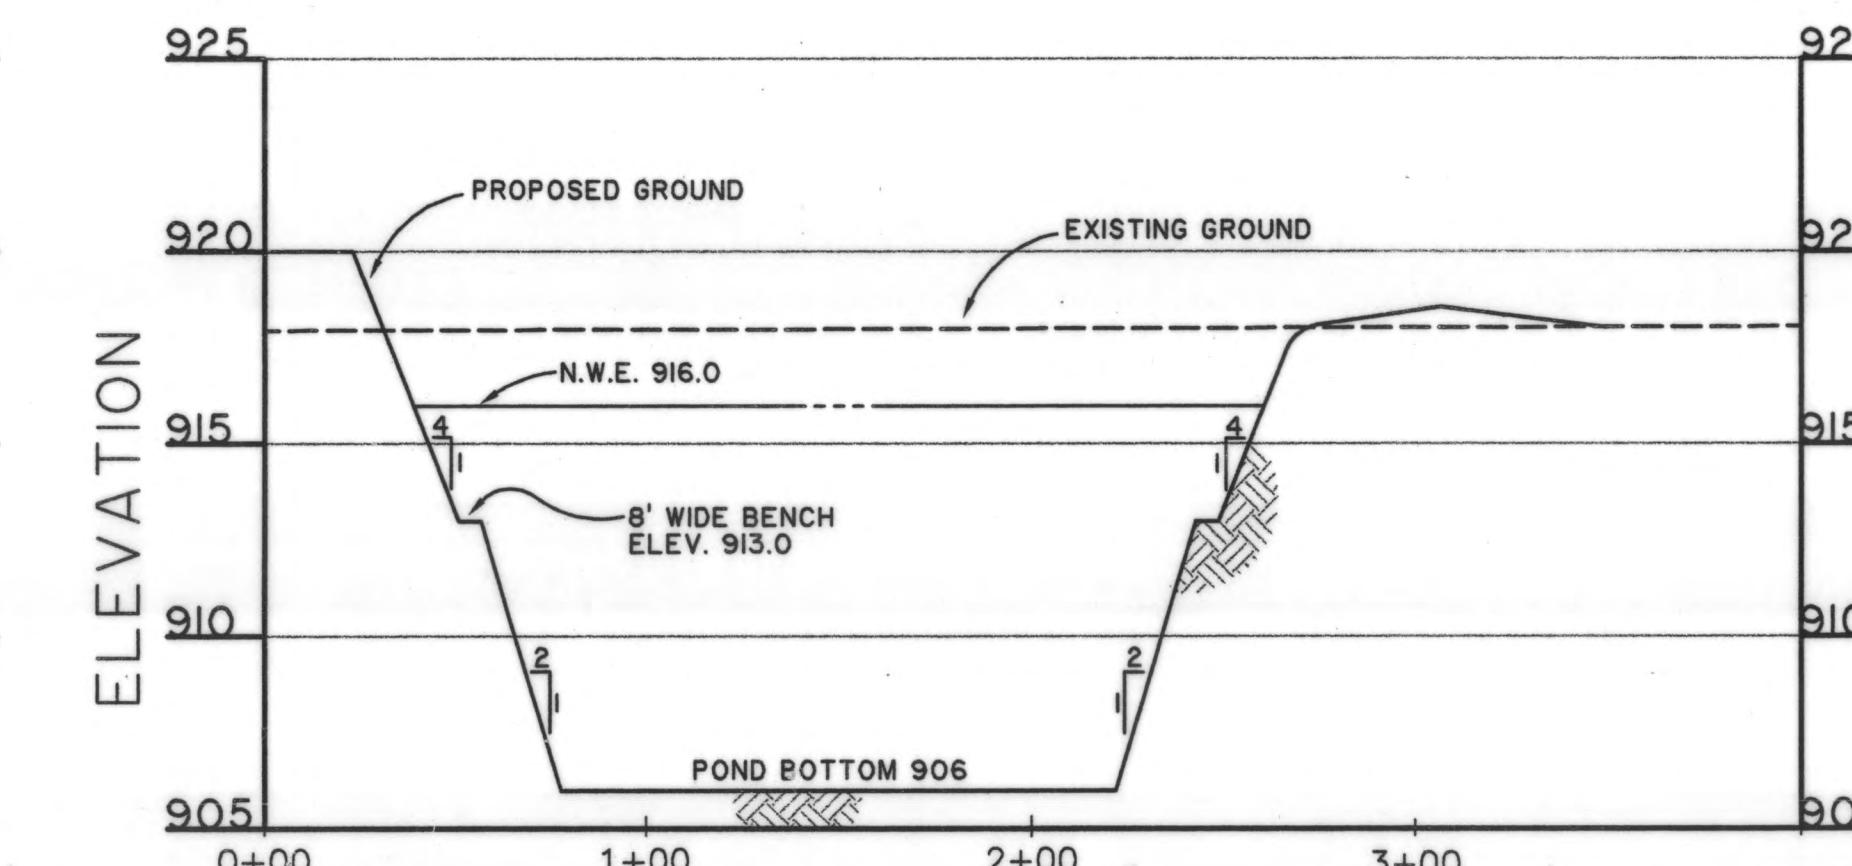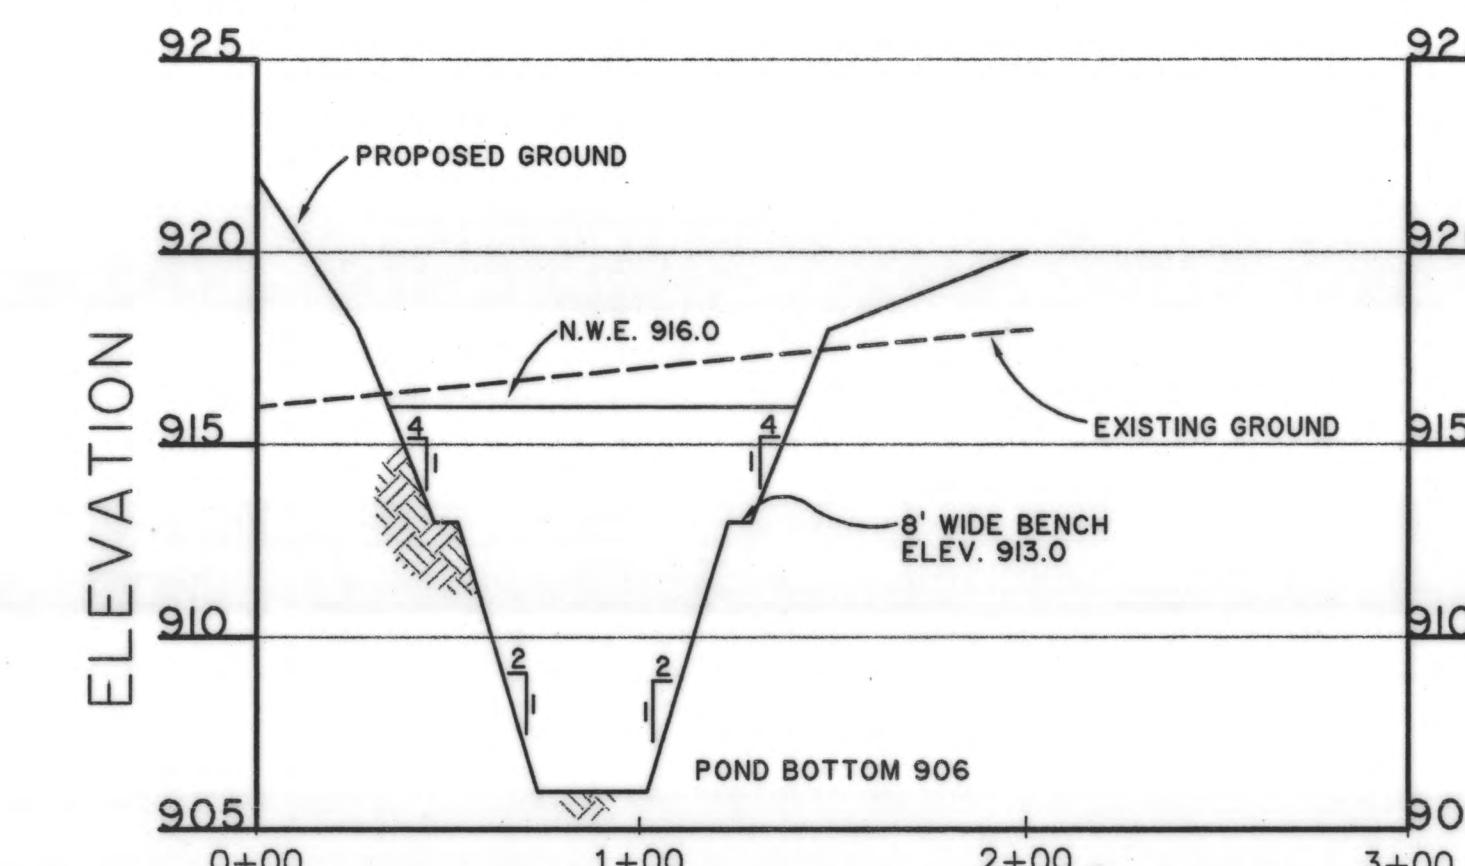


STAGE STORAGE - HOLE 15

ELEVATION (FT.)	AREA (SQ. FT.)	ACCUMULATIVE DEPTH (FT.)	VOLUME (CU. FT.)	CUMULATIVE (ACRES FT.)
904.0	37400	4	171200	3.93
908.0	48200	5	49600	5.07
909.0	51000	6	52450	6.27
910.0	53900	7	55400	7.54
911.0	56900	8	65050	9.04
912.0	73200	12	359800	17.30
916.0	106700	13	111600	19.86
917.0	116500	14	121450	22.65
918.0	126400	15	131400	25.66
919.0	136400	16	141450	28.91
920.0	146500	17	151950	32.40
921.0	157400			

STAGE STORAGE - HOLE 16


ELEVATION (FT.)	AREA (SQ. FT.)	ACCUMULATIVE DEPTH (FT.)	VOLUME (CU. FT.)	CUMULATIVE (ACRES FT.)
906.0	8300	3	29175	0.67
909.0	11150	4	11925	0.94
910.0	12700	5	13543	1.25
911.0	14385	6	15293	1.61
912.0	16200	7	19750	2.06
913.0	23300	8	25200	2.64
914.0	27100	9	29050	3.30
915.0	31000	10	32950	4.06
916.0	34900	11	36950	4.91
917.0	39000	12	41000	5.85
918.0	43000			

0 50' 100'

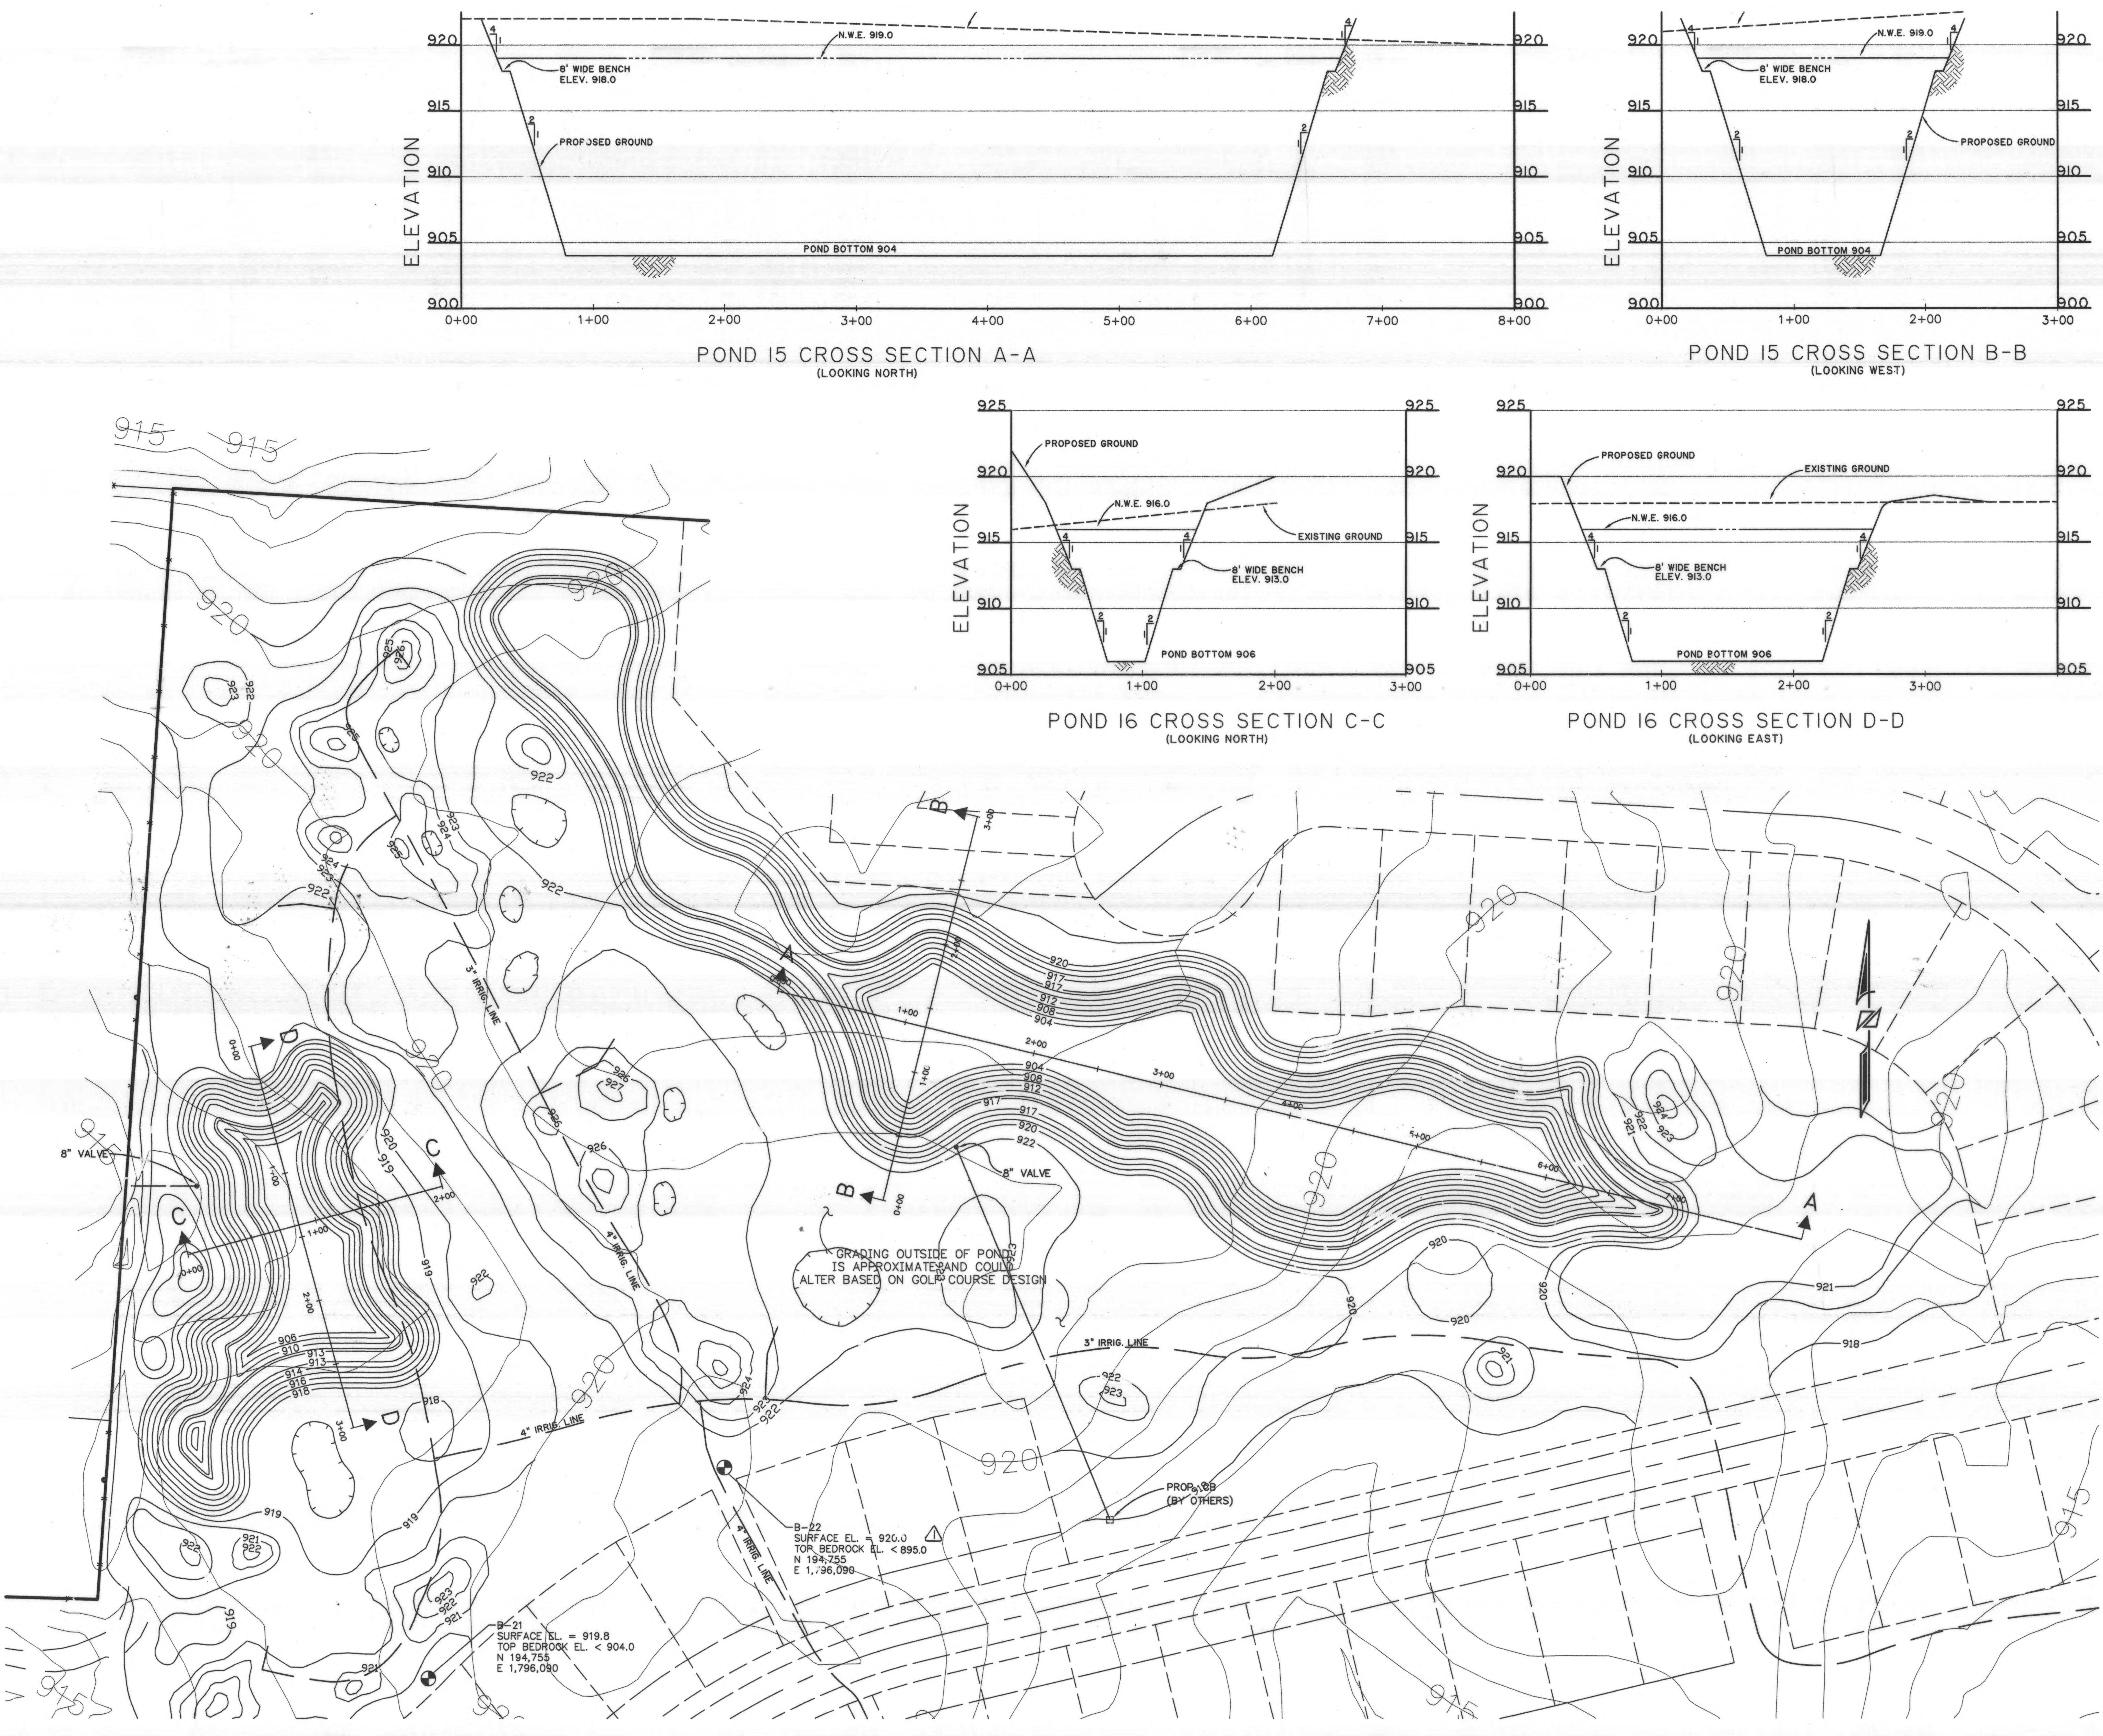

DESIGNED BY: xxx	REVISIONS
DRAWN BY: ADM	DATE
CHECKED BY: xxx	REMARKS
APPROVED BY: xxx	4/9/99 REVISE BORE LABEL AND STAGE STORAGE TABLE
DATE: JANUARY 25, 1999	
JOB NO. 4363EN	

DELAWARE COUNTY
DELAWARE COUNTY SANITARY ENGINEER

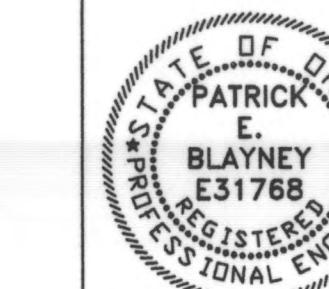

SCIOTO RESERVE
IRRIGATION POND

SCALE:
1'=50'

IRRIGATION POND
HOLE NOS. 15 & 16

SHEET NO.
IP-8

GENERAL NOTES

GENERAL

ALL WORK SHALL BE DONE AND ALL MATERIAL FURNISHED IN ACCORDANCE WITH THE STATE OF OHIO DEPARTMENT OF TRANSPORTATION, CONSTRUCTION AND MATERIAL SPECIFICATIONS, LATEST EDITION AND CURRENT DELAWARE COUNTY SPECIFICATIONS. SEWER STANDARD DRAWINGS REFER TO THE DELAWARE COUNTY SANITARY ENGINEERING DEPARTMENT STANDARD DRAWINGS.

PROPOSED 8" FORCE MAIN CONDUIT SHALL BE DUCTILE IRON IN ACCORDANCE WITH REQUIREMENTS OF ANSI A 21.51 (AWWA C151) OR POLYVINYL CHLORIDE (PVC) IN ACCORDANCE WITH REQUIREMENTS OF THE AMERICAN SOCIETY FOR PLASTIC MATERIALS (ASPM) IN ACCORDANCE WITH REQUIREMENTS OF AWWA C900, MECHANICAL AND PUSH-ON JOINTS INCLUDING ACCESSORIES SHALL CONFORM TO ANSI A 21.11 (AWWA C111). PROPOSED 2" FORCE MAIN CONDUIT SHALL BE PVC SDR 21.

ALL ROCK EXCAVATION NECESSARY FOR INSTALLATION OF FORCE MAIN AND STRUCTURAL SHALL BE INCLUDED IN THE PRICE BID FOR THE VARIOUS CONTRACT ITEMS.

ALL PIPE, FITTINGS AND VALVES SHALL BE CAREFULLY LOWERED INTO THE TRENCH PIECE BY PIECE BY MEANS OF A DERRICK, ROPES OR OTHER SUITABLE TOOLS OR EQUIPMENT. ALL PIPE, FITTINGS AND VALVES SHALL BE INSPECTED AND PROTECTIVE COATINGS AND LINERS, THE PIPE AND FITTING SHALL BE INSPECTED FOR DEFECTS AND, WHILE SUSPENDED ABOVE GRADE, BE RUNG WITH A LIGHT HAMMER TO DETECT CRACKS. AT TIMES WHEN PIPE LAYING IS NOT IN PROGRESS, THE OPEN ENDS OF PIPE SHALL BE CLOSED BY A WATERTIGHT PLUG OR OTHER MEANS APPROVED BY THE ENGINEER.

CONCRETE BLOCKING SHALL BE USED ON ALL HORIZONTAL AND VERTICAL BENDS AS SHOWN ON STANDARD DRAWING NO. 23 AND 24. COST FOR BLOCKING SHALL BE INCLUDED IN THE PRICE BID FOR THE FORCE MAIN.

THE SURFACES WITH WHICH THE RUBBER GASKET COMES IN CONTACT SHALL BE CLEANED THOROUGHLY JUST PRIOR TO ASSEMBLY.

ALL VALVES OUTSIDE STRUCTURES SHALL BE PROVIDED WITH VALVE BOXES. VALVES SHALL BE SET ON FOUNDATION SO THAT NO LOAD WILL BE TRANSFERRED TO THE CONNECTING PIPE. VALVE BOXES SHALL BE OF STANDARD ADJUSTABLE, HEAVY PATTERN, CAST IRON, EXTENSION TYPE, OF SUCH LENGTH AS IS REQUIRED.

IF THE VALVE BOX OUTSIDE STRUCTURE IS MORE THAN 12 INCHES BELOW FINISHED GRADE AN EXTENSION STEM SHALL BE FURNISHED TO BRING THE TOP OF THE OPERATING NUT ALONG WITH 24 INCHES OF FINISHED GRADE.

PROVIDE MINIMUM COVER FOR FORCE MAIN AS SHOWN ON THE PLATE AND PROFILE DRAWINGS. MAINTAIN THE PROFILE GRADES IN ORDER TO PROVIDE HIGH POINTS AT LOCATIONS DESIGNATED FOR AIR RELEASE VALVES.

COMMENCEMENT OF WORK
THE CONTRACTOR SHALL NOTIFY THE DELAWARE COUNTY SANITARY DEPARTMENT 48 HOURS PRIOR TO COMMENCING WORK ON THIS PROJECT, HOLIDAYS AND WEEKENDS EXCLUDED.

EXTRA COMPENSATION

NO EXTRA COMPENSATION WILL BE PAID TO THE CONTRACTOR BY REASON OF COMPLIANCE WITH ANY OF THE REQUIREMENTS INDICATED IN THE CONTRACT DRAWINGS. STAFF SHALL BE DEEMED TO BE INCLUDED AMONG THE PAY ITEMS, AS BID UPON, UNLESS OTHERWISE SPECIFICALLY PROVIDED.

SAFETY REQUIREMENTS

THE CONTRACTOR AND SUB-CONTRACTOR SHALL BE SOLELY RESPONSIBLE FOR COMPLYING WITH THE OCCUPATIONAL SAFETY AND HEALTH ACT OF 1970 AND ALL AMENDMENTS THERETO, DURING THE CONDUCT AND PERFORMANCE ON AND IN CONJUNCTION WITH THIS PROJECT.

STATIONING

STATIONING ALONG THE FORCE MAINS ARE BASED ON DISTANCES ALONG THE PIPE, CENTERLINE. BASELINE AND CENTERLINE ARE FIELD LOCATED WITH THE REFERENCE POINTS SHOWN ON THE DRAWING.

BENCHMARKS AND ELEVATIONS

ALL ELEVATIONS SHOWN ARE BASED ON U.S.G.S. DATUM. BENCHMARKS HAVE BEEN SET AND REFERENCED ON THE DRAWINGS. CONTRACTOR SHALL VERIFY ELEVATION ON EACH WITH PERMANENT BENCHMARKS PRIOR TO COMMENCING THE WORK. DISCREPANCIES SHALL BE BROUGHT TO THE ATTENTION OF THE COUNTY'S REPRESENTATIVE AND RESOLVED BEFORE PROCEEDING WITH WORK. BENCHMARKS SHALL BE MAINTAINED AS REQUIRED TO COMPLETE THE WORK AT THE CONTRACTOR'S COST.

IRON PINS AND MONUMENTS

THE CONTRACTOR SHALL REFERENCE ALL IRON PINS, AND MONUMENTS FOUND BEFORE EXCAVATING AT OR NEAR THEM. COPIES OF REFERENCE DOCUMENTATION SHALL BE SUBMITTED TO COUNTY. IF ANY PINS OR MONUMENTS ARE DESTROYED OR DAMAGED THEY SHALL BE ACCURATELY REPLACED BY A REGISTERED SURVEYOR AT THE COMPLETION OF THE PROJECT AT CONTRACTOR'S COST.

Maintenance of traffic

ALL TRAFFIC CONTROL DEVICES SHALL BE FURNISHED, ERECTED, MAINTAINED AND REMOVED BY THE CONTRACTOR IN ACCORDANCE WITH THE "OHIO MANUAL OF CONTROL DEVICES FOR CONSTRUCTION AND MAINTENANCE OPERATION" (CURRENT EDITION); COPIES OF WHICH ARE AVAILABLE FROM THE OHIO DEPARTMENT OF TRANSPORTATION, BUREAU OF TRAFFIC, 2 S. FRONT STREET, COLUMBUS, OHIO 43215.

ALL TRENCHES SHALL BE BACKFILLED OR SECURELY PLATED DURING NON-WORKING HOURS. THE CONTRACTOR SHALL BE RESPONSIBLE FOR MAINTAINING "LOCAL" TRAFFIC AT ALL TIMES AND OF NOTIFYING THE PROPER AUTHORITIES REGARDING THE CLOSING OF ROADWAYS.

THE CONTRACTOR SHALL BE RESPONSIBLE FOR THE REMOVAL, STORAGE AND RELOCATION OF ALL PERMANENT TRAFFIC CONTROL DEVICES WITHIN THE PROJECT LIMITS. PERMANENT TRAFFIC CONTROL DEVICES INCLUDE, BUT ARE NOT LIMITED TO PAVEMENT MARKINGS AND SIGNS.

THE CONTRACTOR SHALL NOT BEGIN WORK UNTIL STANDING BARRICADES AND WARNING SIGNS ARE IN ACCEPTABLE POSITION AND THE MARKERS AND SIGNS CONFORM TO THE "OHIO MANUAL OF UNIFORM TRAFFIC CONTROL DEVICES FOR STREETS AND HIGHWAYS".

TWO-WAY, ONE LANE TRAFFIC SHALL BE MAINTAINED ON HOME ROAD AT ALL TIMES DURING WORKING HOURS IN ACCORDANCE WITH PAGE C-22 OF THE OHIO MANUAL.

THE CONTRACTOR SHALL MAINTAIN LOCAL TRAFFIC AT ALL TIMES DURING CONSTRUCTION OF THIS PROJECT, INCLUDING DURING THE PAST IN CONVENIENCE OF INCONVENIENCE TO THE ADJOINING PROPERTY OWNERS. TEMPORARY DRIVEWAYS, TEMPORARY ROADWAYS, OR RUN-AROUNDS AS MAY BE NECESSARY TO PROVIDE VEHICULAR ACCESS TO AND FROM THE ABUTTING PROPERTIES SHALL BE CONSTRUCTED, MAINTAINED AND SUBSEQUENTLY REMOVED BY THE CONTRACTOR AS DIRECTED BY THE ENGINEER.

ALL PAVEMENT AND/OR RIGHT-OF-WAY OPENINGS WITHIN THE PUBLIC RIGHT-OF-WAY MUST CONFORM TO THE CURRENT EDITION OF THE STATE OF OHIO DEPARTMENT OF TRANSPORTATION, CONSTRUCTION AND MATERIAL SPECIFICATIONS, WITH SUPPLEMENTS OR CHANGES THERETO. ALSO, THE CONTRACTOR ASSUMES ALL RESPONSIBILITIES AND LIABILITIES REGARDING STRICT ADHERENCE TO APPLICABLE SECTIONS FOR THE MAINTENANCE OF TRAFFIC CONTROL DEVICES SET FORTH IN THE "OHIO MANUAL OF UNIFORM TRAFFIC CONTROL DEVICES FOR STREETS AND HIGHWAYS". ALL TRAFFIC CONTROL DEVICES MUST BE IN PLACE PRIOR TO STARTING CONSTRUCTION.

THE PORTION OF THE PAVEMENT NOT IN THE SEWER MAIN CONSTRUCTION SHALL BE KEPT CLEAR OF ALL EXCAVATED MATERIAL. ONLY A PORTION OF THE TRENCH SHALL BE EXCAVATED AT A TIME AND CLOSED AGAIN WITH GRANULAR MATERIAL BEFORE THE PAVEMENT OVER THE BALANCE IS REMOVED, AS DIRECTED BY THE ENGINEER.

EXCAVATION WHICH ARE NOT PROTECTED BY TEMPORARY FENCING SHALL BE BACKFILLED AT THE END OF EACH WORKING DAY.

IF AT ANY TIME TRAFFIC HAS TO BE BLOCKED, THE CONTRACTOR SHALL NOTIFY THE NEAREST FIRE AND POLICE DEPARTMENTS (EMERGENCIES ONLY).

NO NON-RUBBER TIRED VEHICLES SHALL BE MOVED ON COUNTY ROADS.

EXISTING UTILITIES

THE CONTRACT DRAWINGS SHOW ALL UTILITIES, WATER, GAS, AND SEWER LINES KNOWN TO EXIST; HOWEVER, THIS DOES NOT GUARANTEE THAT ALL EXISTING LINES AND APPURTENANCES HAVE BEEN SHOWN ON THE CONTRACT DRAWINGS. AND THE COUNTY ASSUMES NO RESPONSIBILITY FOR THE ACCURACY THEREOF AND DOES NOT FREE THE CONTRACTOR FROM THE NECESSARY PRECAUTIONS FOR THE PROTECTION OF ANY UTILITY ENCOUNTERED ON THE PROJECT OR THE RESTORATION OF ANY UTILITY DAMAGED DURING CONSTRUCTION.

THE CONTRACTOR SHALL EXPOSE THE UTILITY OR STRUCTURE INDICATED ON THE DRAWING BEFORE PERFORMING THE ASSOCIATED WORK IN ORDER TO VERIFY THE LOCATION.

THE CONTRACTOR SHALL NOTIFY AT LEAST 48 HOURS BEFORE BREAKING GROUND, ALL PUBLIC AND/OR PRIVATE SERVICE CORPORATIONS HAVING WIRE, POLES, PIPES, CONDUITS, STORM SEWERS, ETC., SHALL BE NOTIFIED IN ADVANCE OF ANY WORK IN OPERATION, INCLUDING ALL STRUCTURES WHICH ARE AFFECTED AND NOT SHOWN ON THESE PLANS. OWNERS OF UNDERGROUND UTILITIES WHICH ARE MEMBERS OF THE OHIO UTILITIES PROTECTION SERVICE CAN BE NOTIFIED BY CALLING 800-362-2764 (TOLL FREE). NON-MEMBER UNDERGROUND UTILITY OWNERS MUST BE CALLED DIRECTLY.

THE CONTRACTOR SHALL BE RESPONSIBLE FOR NOTIFYING ALL RESIDENTS OF INTEREST AND OWNERS OF UTILITIES THAT WILL BE CAUSED BY CONSTRUCTION AT LEAST 24 HOURS IN ADVANCE.

SUPPORTING AND/OR PROTECTING EXISTING WATER LINES, GAS MAINS, TELEPHONE CONDUIT, STORM SEWERS, ETC., SHALL BE INCLUDED IN PAYMENT FOR THE VARIOUS CONTRACT ITEMS OF WORK.

ALL WORK REQUIRED FOR THE MAINTENANCE OF SERVICE OF EXISTING UTILITIES SHALL BE DONE BY AND AT THE EXPENSE OF THE CONTRACTOR.

ALL MAINTENANCE, REPAIR AND/OR REPLACEMENT OF EXISTING UTILITIES, WHETHER SHOWN ON THE DRAWINGS OR NOT, SHALL BE IN ACCORDANCE WITH THE RULES AND REGULATIONS OF THE VARIOUS UTILITY COMPANIES HAVING JURISDICTION, AND SHALL BE INCLUDED IN PAYMENT FOR THE VARIOUS CONTRACT ITEMS OF WORK.

ALL EXISTING STORM SEWERS, DRIVEWAY DRAINS, AND OTHER SURFACE DRAIN PIPES, WHETHER SHOWN ON THE CONTRACT DRAWINGS OR NOT, REMOVED OR DAMAGED DURING CONSTRUCTION SHALL BE REPAVED AND RECONNECTED BY THE CONTRACTOR AS DIRECTED BY THE ENGINEER, AT NO COST TO THE CONTRACTOR.

IT IS ASSUMED THAT THERE ARE WATER AND GAS BRANCH LINES, ELECTRIC AND TELEPHONE SERVICES, ETC., LOCATED EACH RESIDENCE. THE CONTRACTOR SHALL REPAIR AND REPLACE THESE UTILITIES IF DAMAGED AT NO COST TO THE CONTRACTOR.

COLUMBUS SOUTHERN POWER

CONTRACTOR SHALL CONTACT THE COMPANY PRIOR TO EXCAVATION IN THE VICINITY OF ELECTRIC UNDERGROUND FACILITIES (APPROXIMATE PLAN LOCATION SHOWN) OR WHEN WORKING NEAR OVERHEAD ELECTRIC FACILITIES.

(A) FOR FIRE INSPECTOR TO LOCATE UNDERGROUND ELECTRIC LINE IN OHIO CALL "OHIO UTILITIES PROTECTION SERVICE" - 800-362-2764, AT LEAST 48 HOURS IN ADVANCE, EXCLUDING HOURS, SAT., SUN., AND STATE LEGAL HOLIDAYS.

CONTRACTOR SHALL BE RESPONSIBLE FOR ALL DAMAGES TO ELECTRIC FACILITIES DURING CONSTRUCTION.

ELECTRIC FACILITIES TO BE KEPT IN SERVICE AT ALL TIMES.

CONTRACTOR SHALL BE RESPONSIBLE FOR SUPPORTING EXISTING ELECTRIC FACILITIES AFFECTED BY THE PROPOSED CONSTRUCTION.

(A) WHERE CONCRETE ENCASED CONDUIT SYSTEMS OR DIRECT BURIED CABLE SYSTEMS ARE EXPOSED OR OTHERWISE INTERFERED WITH, THE CONTRACTOR SHALL PROTECT THE EXPOSED DAMAGED AND PRIMARILY SUPPORT TO ENSURE THE INTEGRITY OF THE SYSTEM, AS SOON AS FEASIBLE. THE CONTRACTOR SHALL TAKE ADDITIONAL APPROPRIATE STEPS TO PROVIDE PERMANENT MEASURES TO RESTORE SUPPORT. THE METHODS USED SHALL BE BASED ON CONDITIONS TO BE DETERMINED BY THE UTILITY.

(B) WHERE POLES OR ANCHORS THAT SUPPORT OVERHEAD ELECTRIC FACILITIES ARE EXPOSED OR OTHERWISE INTERFERED WITH, THE CONTRACTOR SHALL PROTECT THE EXPOSED DAMAGED AND PRIMARILY SUPPORT TO ENSURE THE INTEGRITY OF THE SYSTEM, AS SOON AS FEASIBLE. THE CONTRACTOR SHALL TAKE ADDITIONAL APPROPRIATE STEPS TO PROVIDE PERMANENT MEASURES TO RESTORE SUPPORT. THE METHODS USED SHALL BE BASED ON CONDITIONS TO BE DETERMINED BY THE UTILITY.

(C) WHERE THE DEPTH OF EXCAVATION FOR THE PROPOSED WORK IS GREATER THAN FIVE (5) FEET, THE CONTRACTOR SHALL SHEET AND SHORE THE TRENCH TO CONVENTIONAL STANDARDS. SUPPORT ELECTRIC FACILITIES AND CONDUITS WHERE THE ELECTRIC FACILITIES ARE WITHIN THE ZONE OF INFLUENCE ADJACENT TO THE EXCAVATION AS DETERMINED BY THE NATURAL ANGLE OF RESPONSE OF THE SOIL.

(D) ALL DAMAGE TO ELECTRIC FACILITIES AND SERVICES REQUIRING ADJUSTMENTS, RELOCATIONS AND/OR REPAIRS WILL BE MADE AT THE CONTRACTOR'S COST.

CONTRACTOR SHALL NOT BACKFILL EXPOSED ELECTRIC FACILITIES UNTIL THE COMPANY HAS INSPECTED ITS FACILITY OR PERFORMED ANY ADJUSTMENTS AND/OR MAINTENANCE THAT MAY BE REQUIRED.

SHOULD CONTRACTOR DAMAGE ELECTRIC FACILITIES, CONTRACTOR SHALL IMMEDIATELY NOTIFY THE ELECTRIC SERVICE DESK THROUGH THE COMPANY OPERATOR. CONTRACTOR SHALL MAKE EVERY EFFORT TO REPAIR OR DAMAGE ELECTRIC FACILITIES UNTIL COMPANY PERSONNEL ARRIVE AT THE WORK SITE.

COLUMBIA GAS OF OHIO
SUBURBAN NATURAL GAS

GAS FACILITIES ARE TO BE KEPT IN SERVICE AT ALL TIMES.

THE CONTRACTOR SHALL BE RESPONSIBLE FOR ALL DAMAGES TO GAS FACILITIES DURING OR AS A RESULT OF HIS CONSTRUCTION. ALL DAMAGE TO GAS FACILITIES REQUIRING ADJUSTMENTS, RELOCATIONS AND/OR REPAIRS WILL BE MADE AT THE CONTRACTOR'S COST.

THE COST OF THIS WORK SHALL BE INCLUDED IN THE UNIT PRICE BID FOR THE VARIOUS CONTRACT ITEMS.

THE CONTRACTOR SHALL SHEET AND SHORE ALL EXCAVATIONS AS REQUIRED TO CONTINUOUSLY SUPPORT GAS FACILITIES WITHIN THE ZONE OF INFLUENCE (AS DETERMINED BY THE NATURAL ANGLE OF REPOSE OF THE SOIL).

CROSSING BURIED GAS FACILITIES WITH HEAVY CONSTRUCTION EQUIPMENT MAY CAUSE DAMAGE. CONTRACTOR TO CONTACT THE GAS CONSTRUCTION ENGINEERING DEPT. FOR DETAILS ON HOW TO PROTECT THE GAS FACILITIES FROM DAMAGE.

THE CONTRACTOR SHALL NOT BACKFILL EXPOSED GAS FACILITIES UNTIL THE UTILITY HAS INSPECTED ITS FACILITIES AND PERFORMED ANY MAINTENANCE AND/OR ADJUSTMENTS THAT MAY BE REQUIRED.

THE CONTRACTOR IS RESPONSIBLE FOR PROTECTING AGAINST DAMAGE TO THE COATING AND WRAPPING OF STEEL WELDED GAS MAINS.

DEL-CO WATER

THE CONTRACTOR IS ADVISED THAT DUE TO THE PROXIMITY OF THE PROPOSED FORCE MAIN, THE INTEGRITY OF THE EXISTING WATER MAINS MUST BE MAINTAINED AT ALL TIMES.

IF DURING CONSTRUCTION THE EXISTING WATER MAIN(S) BECOME DISTURBED, THE CONTRACTOR MUST IMMEDIATELY NOTIFY THE WATER SITUATION AND PROVIDE DEL-CO WATER AND THE COUNTY WITH A PLAN OF SUPPORTING THE EXISTING WATER MAIN SO THAT FURTHER DAMAGE DOES NOT OCCUR. REPLACEMENT OF WATER MAIN MAY BE NECESSARY.

ALL CONCRETE THRUST BLOCKING OF EXISTING BENDS MUST NOT BE DISTURBED. SHOULD IT BE NECESSARY TO DO ANY WORK WHICH COULD POSSIBLY ALTER OR IMPAIR THE EXISTING BENDS, THE CONTRACTOR SHALL REPAIR ALL JOINTS WHICH WOULD BE AFFECTED. THIS WORK MUST BE APPROVED BY DEL-CO WATER.

DEL-CO WATER WILL NOT BE LIABLE FOR ANY COST RELATED TO THE REQUIREMENTS OF ITEMS ABOVE. ALL COST SHALL BE BORNE BY THE CONTRACTOR AND INCLUDED IN THE VARIOUS BIKE ITEMS.

TELEPHONE

CONTRACTOR SHALL NOT CONTACT THE COMPANY PRIOR TO EXCAVATION IN THE VICINITY OF UNDERGROUND TELEPHONE FACILITIES (APPROXIMATE PLAN LOCATION SHOWN) OR WHEN WORKING NEAR OVERHEAD TELEPHONE FACILITIES.

CONTRACTOR SHALL COORDINATE CROSSING OF THE EXISTING GTE FIBER OPTIC CABLE WITH SCOTT EARLY AT (740) 369-5109. CONTRACTOR SHALL BE RESPONSIBLE FOR ANY DAMAGE TO THE FIBER OPTIC CABLE DURING CONSTRUCTION. ALL DAMAGE TO THE FIBER OPTIC CABLE REQUIRING ADJUSTMENTS AND/OR REPAIRS WILL BE MADE AT THE CONTRACTOR'S EXPENSE.

USE OF PREMISES

IN ADDITION TO DIRECT REQUIREMENTS OF THE CONTRACT SPECIFICATION, THE CONTRACTOR SHALL OBSERVE AND CONFORM TO THE SPECIFIC REQUIREMENTS OF ALL RIGHTS-OF-WAY, INCLUDING EQUIPMENT COURT ENTERING RIGHTS-OF-WAY, OR ACTION FILED IN COURT IN ACCORDANCE WITH THE CODE OF APPLICABLE GOVERNING AGENCY.

THE CONTRACTOR SHALL NOT TRESPASS UPON OR IN ANY WAY DISTURB PROPERTY ADJACENT TO THE STREET RIGHT-OF-WAY WITHOUT FIRST OBTAINING WRITTEN PERMISSION FROM THE OWNER TO DO SO. A COPY OF SUCH WRITTEN PERMISSION SHALL BE FURNISHED TO THE ENGINEER.

IF THE CONTRACTOR FINDS IT NECESSARY TO OBTAIN ADDITIONAL WORKING AREA, IT SHALL BE HIS RESPONSIBILITY FOR ITS ACQUISITION. ALL REQUIREMENTS LISTED UNDER THE USE OF PREMISES SHALL APPLY IF ADDITIONAL AREA IS OBTAINED.

THE CONTRACTOR SHALL, AT HIS OWN EXPENSE, RESTORE SUCH PROPERTY TO THE FULL SATISFACTION OF THE OWNER AND SHALL MAINTAIN FROM THE OWNER A WRITTEN RELEASE STATING THAT RESTORATION HAS BEEN SATISFACTORILY MADE. A COPY OF THE WRITTEN RELEASE SHALL BE FURNISHED TO THE ENGINEER.

THE CONTRACTOR SHALL NOT WASTE ANY EXCESS EARTH, STONE, OR OTHER EXCAVATED MATERIAL ON ANY PROPERTY WITHOUT FIRST OBTAINING WRITTEN PERMISSION OF THE OWNER OF THE PROPERTY AND SECURING THE APPROVAL OF THE ENGINEER. ONE COPY OF THE OWNER'S WRITTEN PERMISSION AND ONE COPY OF A WRITTEN RELEASE FROM THE OWNER STATING THAT THE WORK HAS BEEN COMPLETED SATISFACTORILY, SHALL BE FURNISHED TO THE ENGINEER.

ALL ITEMS WITHIN THE STREET RIGHT-OF-WAY SHALL BE REMOVED, OR REMOVED AND REPLACED, OR RESTORED AS REQUIRED BY THE CONTRACT DRAWINGS AND DETAILED PROVISIONS, AS DIRECTED BY THE ENGINEER.

STORAGE OF MATERIALS

THE CONTRACTOR SHALL NOT PARK EQUIPMENT OR STORE MATERIALS WITHIN THE RIGHT-OF-WAY.

PROTECTION OF TREES

SPECIAL CARE SHALL BE TAKEN TO AVOID DAMAGES TO TREES AND THEIR ROOT SYSTEM. MACHINE EXCAVATION SHALL NOT BE USED WHEN, IN THE OPINION OF THE ENGINEER, IT IS LIKELY TO ENDANGER TREE ROOTS. IN CASE OF AN EXCAVATION LINE OF TRENCH FALLS WITHIN THE LIMITS OF THE LIMB SPREAD, THE LEAVING OF HEADERS ACROSS THE TRENCH TO PROTECT ROOTS WILL BE REQUIRED. THE OPERATION OF ALL EQUIPMENT, PARTICULARLY WHEN EMPLOYING BOOMS, THE STORE OF MATERIALS, AND THE DEPOSITION OF EXCAVATED MATERIALS IN THE MANNER WHICH WILL NOT INJURE TREES, TRUNKS, BRANCHES OR THEIR ROOTS.


BRANCHES WHICH OVERHANG THE CONSTRUCTION LIMITS AND WHICH INTERFERE WITH THE OPERATION OF EQUIPMENT SHALL BE TIED BACK TO AVOID DAMAGE. IF POSSIBLE, WHERE INJURY TO BRANCHES IS UNAVOIDABLE, THE BRANCHES SHALL BE SAWED OFF NEATLY AT THE JUNCTURE OR MAIN BRANCH; AND THE CUT AREA SHALL BE PAINTED WITH AN APPROVED TREE PRESERVANT. EXCAVATION BEYOND SOIL SHALL BE REMOVED BY THE CONTRACTOR AT HIS OWN EXPENSE, AND IN THE CASE OF TREES LOCATED ON PRIVATE PROPERTY, RESTITUTION SHALL BE MADE TO THE OWNER BY THE CONTRACTOR.

CLEARING AND GRUBBING

TREES AND SHRUBS WITHIN CONSTRUCTION EASEMENT NOT DESIGNATED TO BE SAVED ON THE DRAWINGS MAY BE REMOVED AND SHALL BE DISPOSED OF WITH NO ADDITIONAL COST TO THE CONTRACTOR.

MAINTAINING FLOW

IT WILL BE THE RESPONSIBILITY OF THE CONTRACTOR, THROUGHOUT THE TENURE OF THE CONTRACT, TO PROVIDE AND MAINTAIN A SUFFICIENT FLAT AT ALL TIMES TO PASS ANY FLASH OR STORM FLOW OF DRINKING WATER, CREEKS, STREAMS, AND RIVERS, AND TO PREVENT ANY BACKWATER FLOODING DUE TO OBSTRUCTION CAUSED BY CONSTRUCTION EQUIPMENT AND/OR

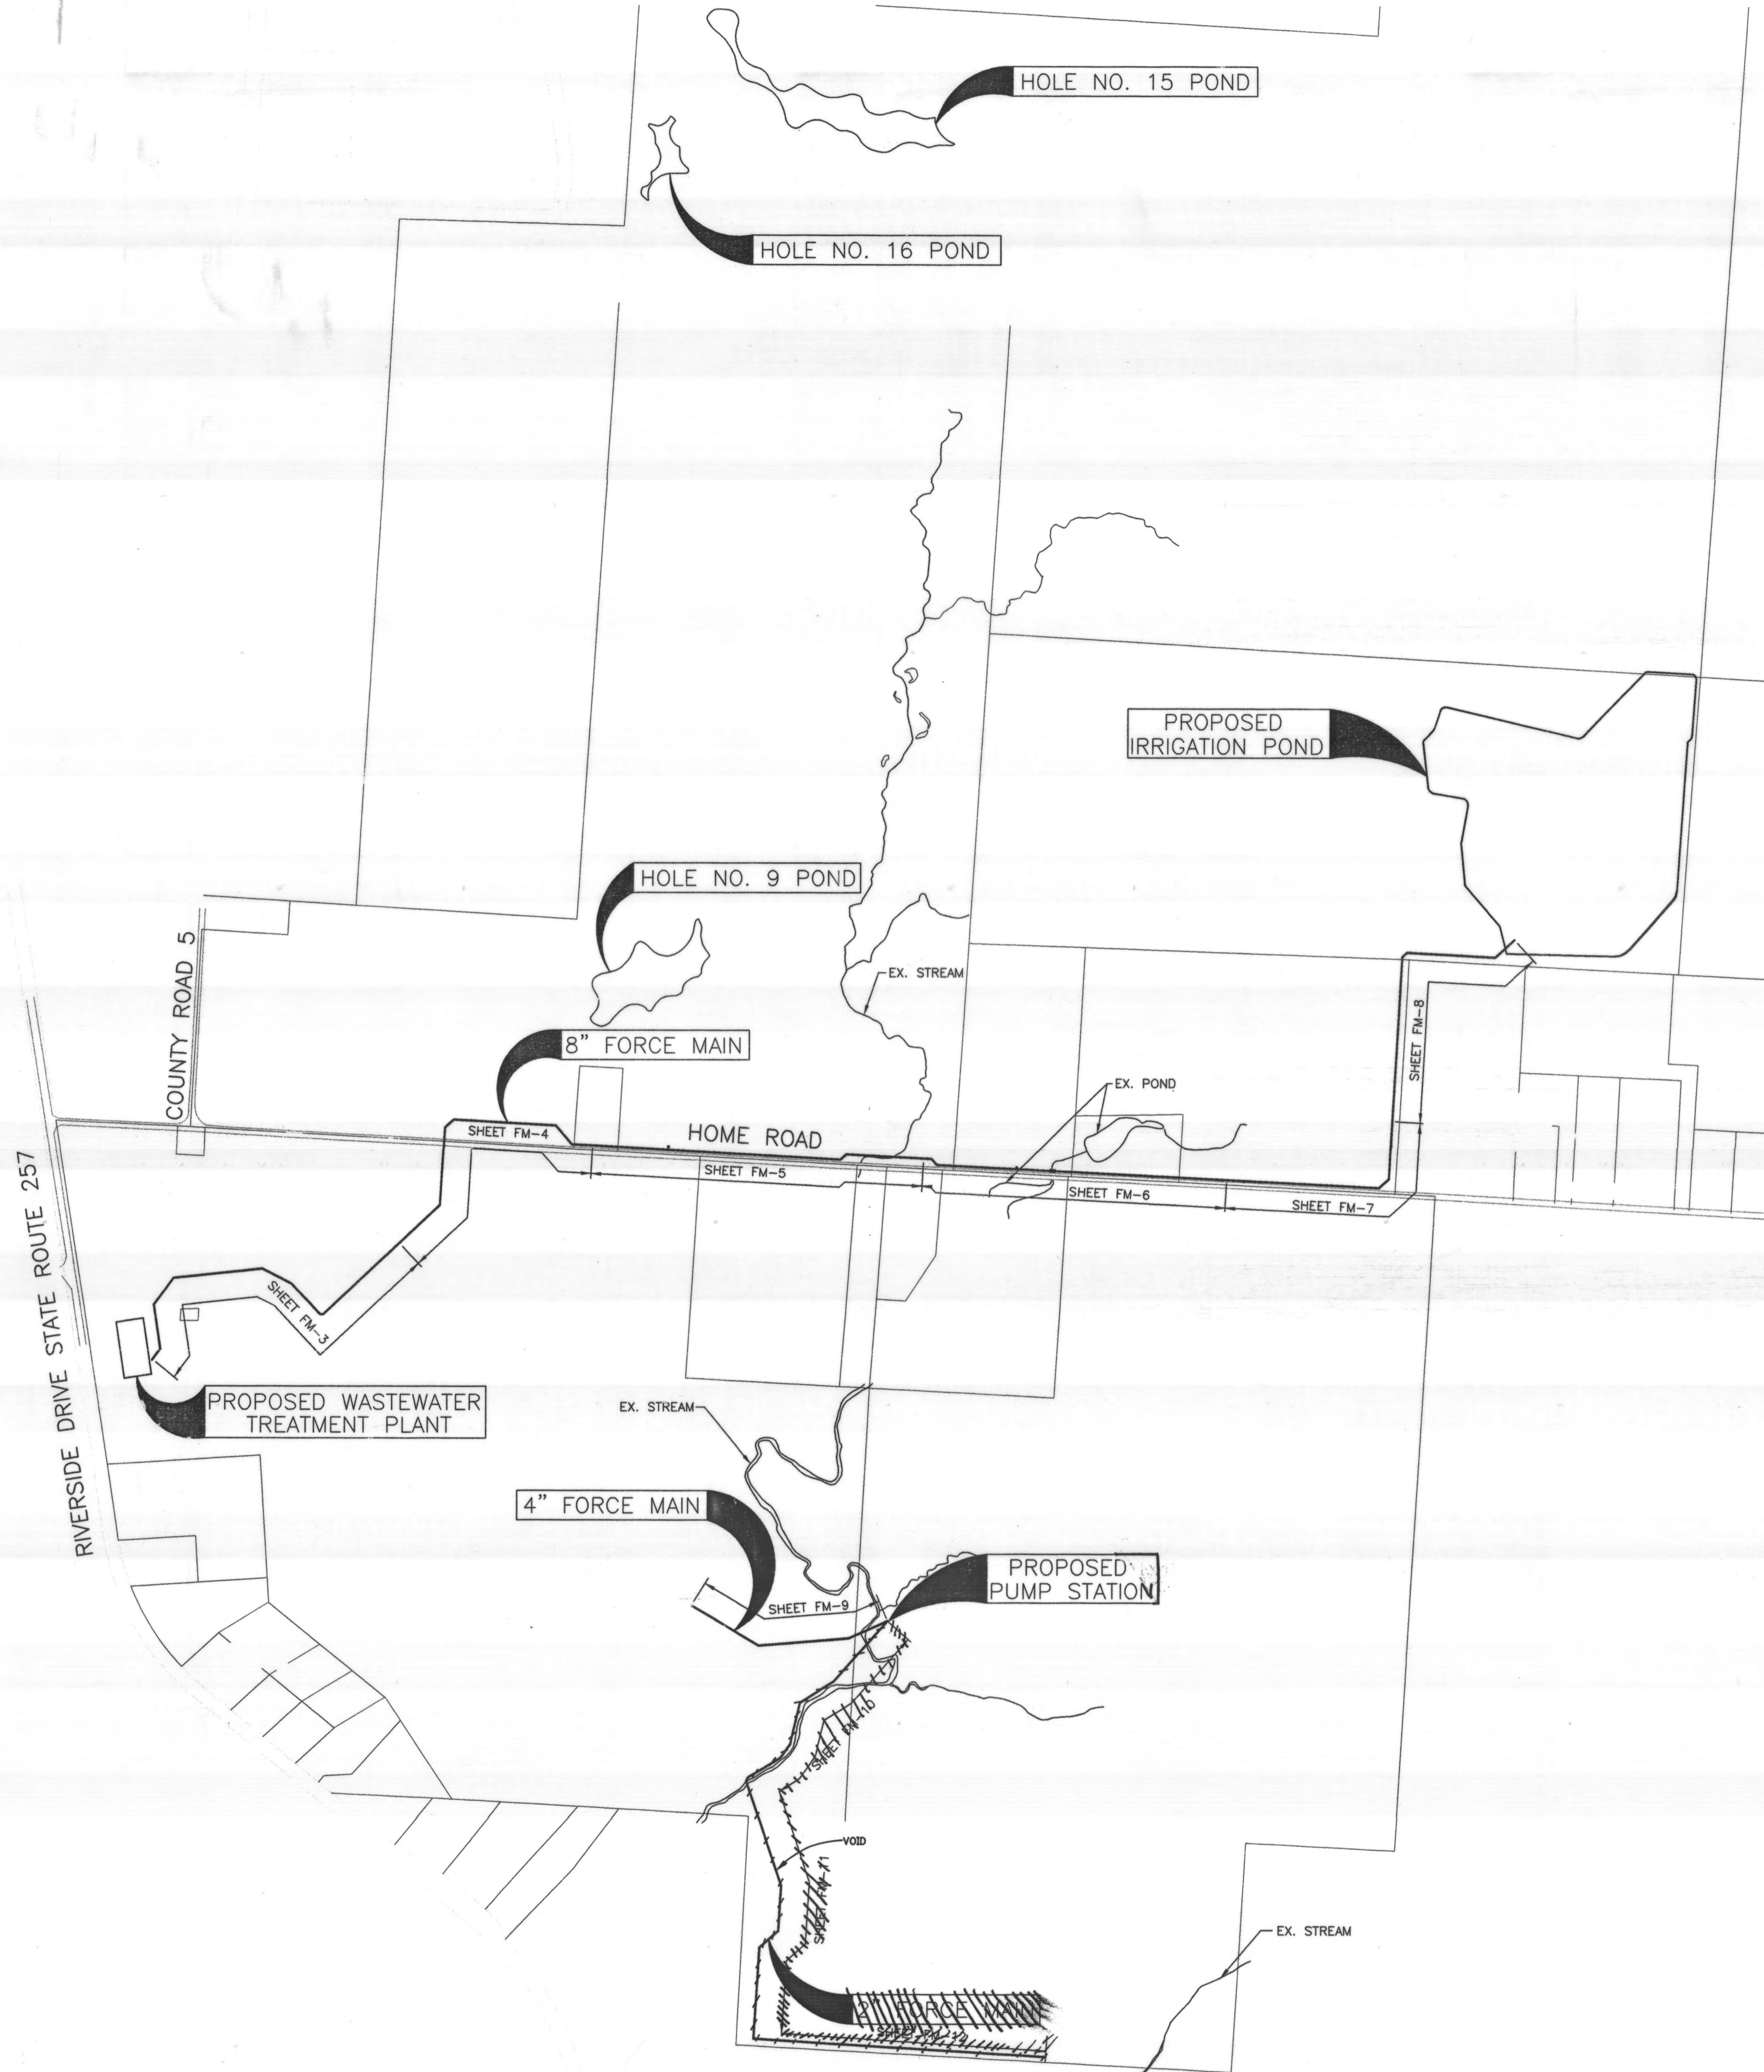


INDEX MAP
SCALE: 1"=300'

R.D.Zande & Associates

DESIGNED BY:	BGD	REVISIONS	REMARKS
DRAWN BY:	ACM	DATE	
CHECKED BY:	THB	1/8/99	2" & 4" ALIGNMENT CHANGE
APPROVED BY:	MBT	1/15/99	8" ALIGNMENT CHANGE
DATE:	JANUARY 25, 1999		
JOB NO.	4363EN		

DELAWARE COUNTY
DELAWARE COUNTY SANITARY ENGINEER

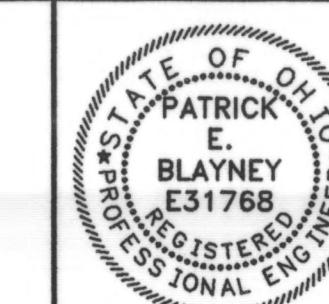

SCIOTO RESERVE
8", 4" & 2" FORCE MAINS


SCALE: AS SHOWN	GENERAL	SHEET NO.
	INDEX MAP AND ESTIMATED QUANTITIES	FM-2

ESTIMATED QUANTITIES		
ITEM/SEC. NO.	DESCRIPTION	UNIT QUANTITY
3.5/3.7/4.3/4.4	8" PIPE AND FITTINGS, DUCTILE IRON CLASS 53 OR PVC AWWA C900	LF 6313
SPEC.	8" GRAVITY SEWER PIPE, PVC SDR 35	LF 187
3.7/4.3/4.4	4" PIPE AND FITTINGS, PVC AWWA C900	LF 760
SPEC.	2" PIPE AND FITTINGS, PVC SDR 21	LF 2622
8.2	SEEDING AND MULCHING	S.Y. 9150
10.1	TEMPORARY PAVEMENT REPLACEMENT	S.Y. 14
201	CLEARING AND GRUBBING	L.S. L.S.
207	TEMPORARY SOIL EROSION AND SEDIMENT CONTROL	L.S. L.S.
601	DUMPED ROCK FILL, TYPE "D"	C.Y. 265
614	Maintaining Traffic	L.S. L.S.
SPEC.	REINFORCED CONCRETE HEADWALL (PER DETAIL ON SHEET 13)	L.S. L.S.
SPEC.	CONCRETE ENCASEMENT (PER DETAIL ON SHEET 13)	C.Y. 85
SPEC.	PERMANENT PAVEMENT REPLACEMENT, TYPE "C" (PER STD. DWG. 22)	S.Y. 14
SPEC.	PERMANENT PAVEMENT REPLACEMENT, TYPE "D" (PER STD. DWG. 22)	S.Y. 50
SPEC.	MH W/ FLUSH-OUT (PER DETAIL ON SHEET 13)	EA. 2
SPEC.	AIR RELEASE MANHOLE (PER DETAIL ON SHEET 13)	EA. 5
SPEC.	VALVE BOX W/ FLUSH-OUT (PER DETAIL ON SHEET 13)	EA. 5
SPEC.	DUPLEX SUBMERSIBLE LIFT STATION, COMPLETE	L.S. 1
3.5/3.7	FITTINGS INCREASE OR DECREASE (CONTINGENCY ITEM)	LBS. 300
4.3/4.4	INCREASE OR DECREASE IN EXCAVATION (CONTINGENCY ITEM)	C.Y. 150

NOTE: SECTION NOS REFER TO "STANDARD PLANS AND SPECIFICATIONS FOR CONSTRUCTION OF SANITARY FACILITIES, DELAWARE COUNTY, OHIO. ITEM NOS, REFER TO ODOT CMS."


FORCE MAIN REFERENCES					
8" FORCE MAIN			4" FORCE MAIN		
STATION	NORTHING	EASTING	STATION	NORTHING	EASTING
0+00.00	193147.40	1791190.92	0+00	192215.85	1793842.17
0+50.00	193187.62	1791220.62	1+51.80	192154.08	1793703.50
2+10.64	193346.48	1791196.75	4+80.06	192127.54	1793376.31
3+29.13	193441.79	1791267.15	7+59.86	192270.62	1793135.86
8+91.18	193501.04	1791826.06			
16+23.78	194005.44	1792357.32			
19+07.32	193989.80	1792640.44			
19+96.41	193922.55	1792698.87			
29+66.57	193870.15	1793667.61	0+00	192233.10	1793824.14
29+94.63	193888.93	1793688.46	8+70.35	192184.96	1793772.82
33+01.43	193872.88	1793994.84	1+00.35	192172.75	1793746.41
33+30.54	193851.24	1794014.32	4+33.11	191922.99	1793535.31
49+18.47	193770.14	1795600.17	5+16.56	191773.71	1793490.04
49+66.74	193802.48	1795636.01	6+40.09	191725.35	1793465.32
57+63.05	194597.48	1795681.67	7+82.24	191654.35	1793339.15
58+04.66	194625.29	1795712.63	7+94.96	191642.86	1793333.50
60+52.58	194611.99	1795960.19	8+91.55	191287.10	1793460.04
62+98.18	194776.00	1796142.92	12+52.72	19106.22	1793450.17
			12+24.44	19106.52	179382.67
			17+45.61	190744.12	179334.12

LEGEND	
BENCHMARK	EX. RIGHT OF WAY
GUY WIRE	EXISTING FENCE
MAILBOX	PROPERTY LINE
UTILITY POLE	WATER LINE
SIGN	TELEPHONE LINE
WATER VALVE	PROPOSED FORCE MAINS
TREE (CONIFER)	EDGE OF PAVEMENT
TREE (DECIDUOUS)	BUILDINGS
TREE LINE	DITCH
BUSH	PROPOSED PROPERTY LINES
DUMPED ROCK FILL	PROPOSED RIGHT OF WAY
COMPACTED GRANULAR BACKFILL	GUARDRAIL
CONCRETE ENCASEMENT	AIR RELEASE MANHOLE
	PAVEMENT REPLACEMENT

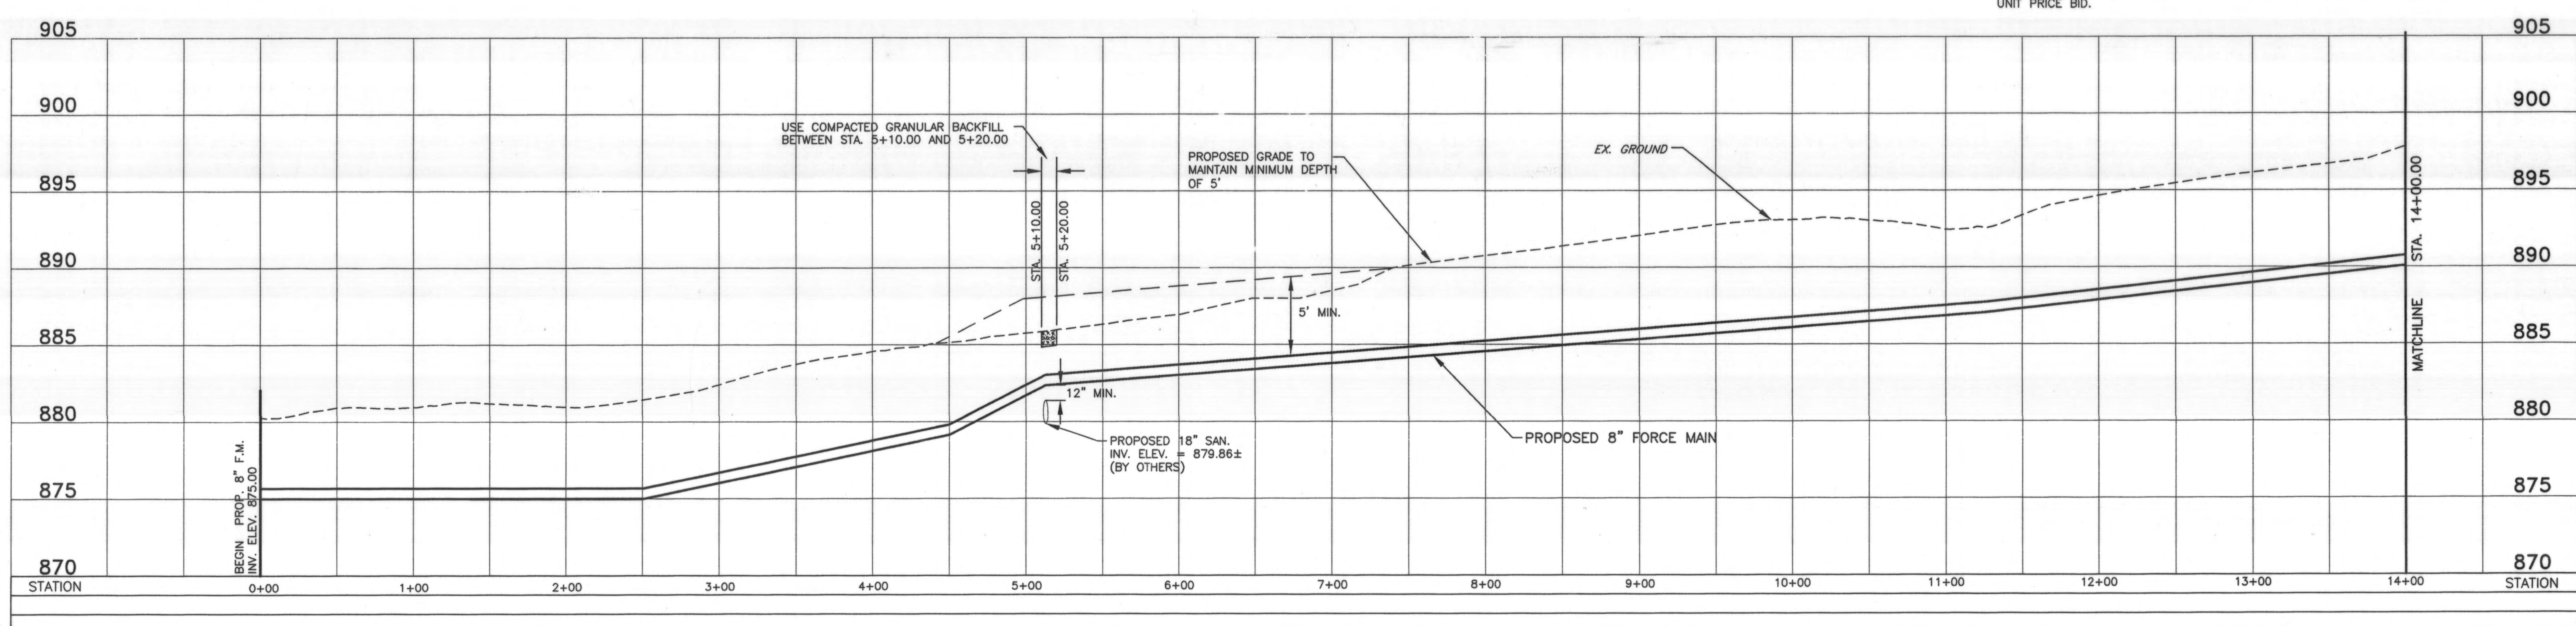

DESIGNED BY:	BGD	REVISIONS	REMARKS
DRAWN BY:	ACM	DATE	
CHECKED BY:	THB	1/8/99	STA. 1+50 TO 11+00
APPROVED BY:	MBT		
DATE:	JANUARY 25, 1999		
JOB NO.	4363EN		




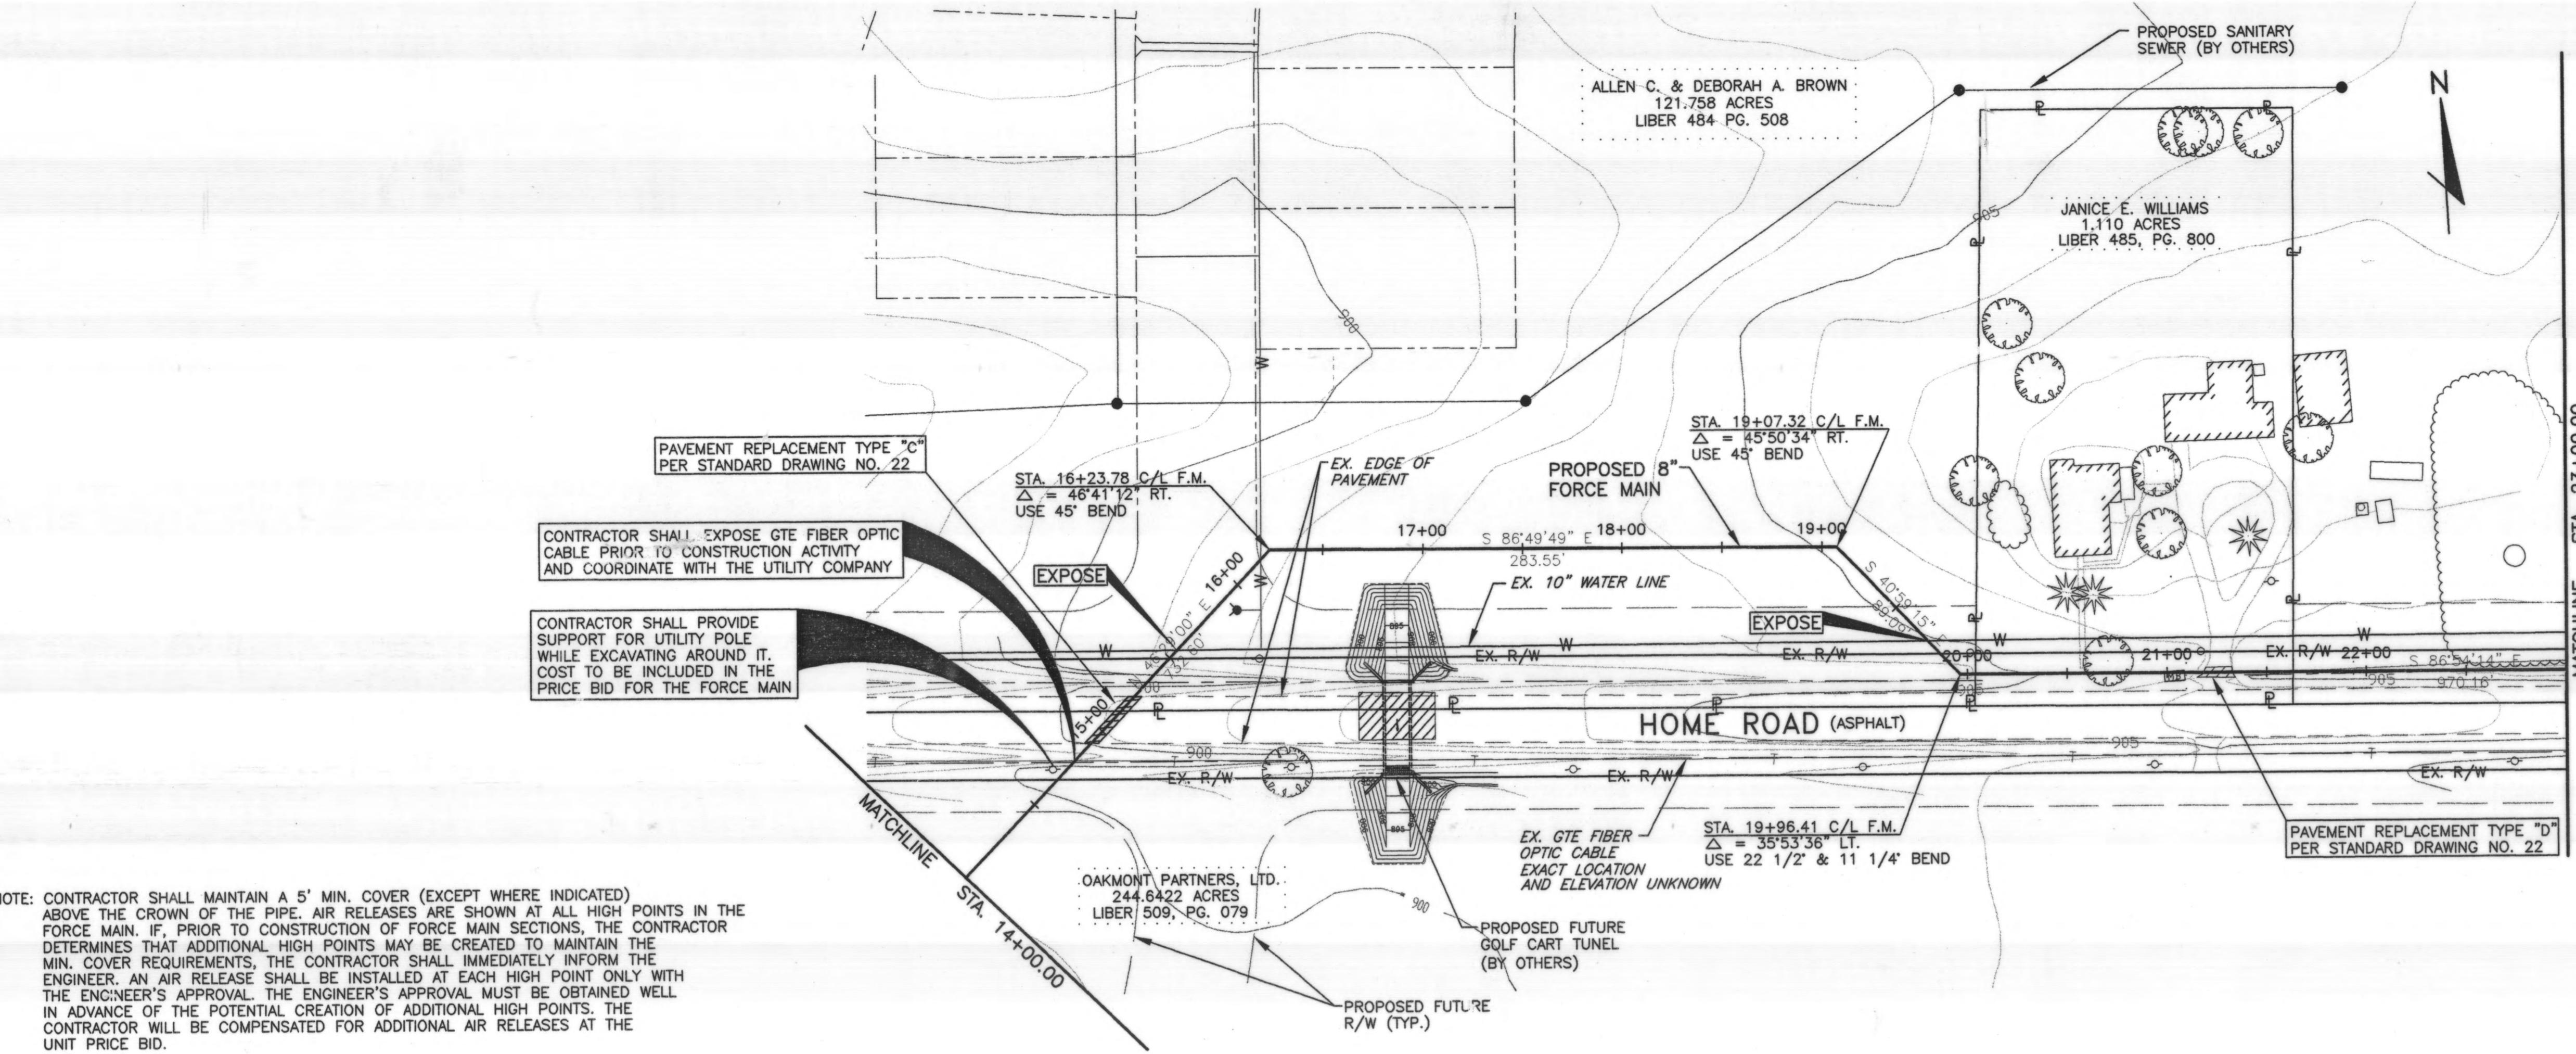

R.D.Zande & Associates

DESIGNED BY:	BGD	REVISIONS		
DRAWN BY:	ACM	DATE	REMARKS	REV. No.
CHECKED BY:	THB	8-25-99	REVISED HORIZONTAL ALIGNMENT OF FORCE MAIN TO AVOID WATERLINE.	▲
APPROVED BY:	NBT			
DATE:	JANUARY 25, 1999			
JOB NO.	4300EN			

DELAWARE COUNTY
DELAWARE COUNTY SANITARY ENGINEER

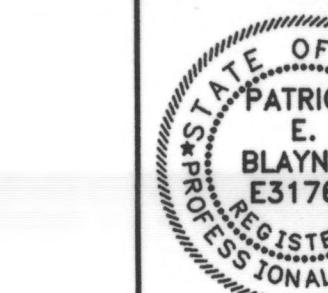




SCIOTO RESERVE
8", 4" & 2" FORCE MAINS

SCALE:
HORZ. 1"=50'
VERT. 1"=5'

PLAN & PROFILE

SHEET NO.
FM-5

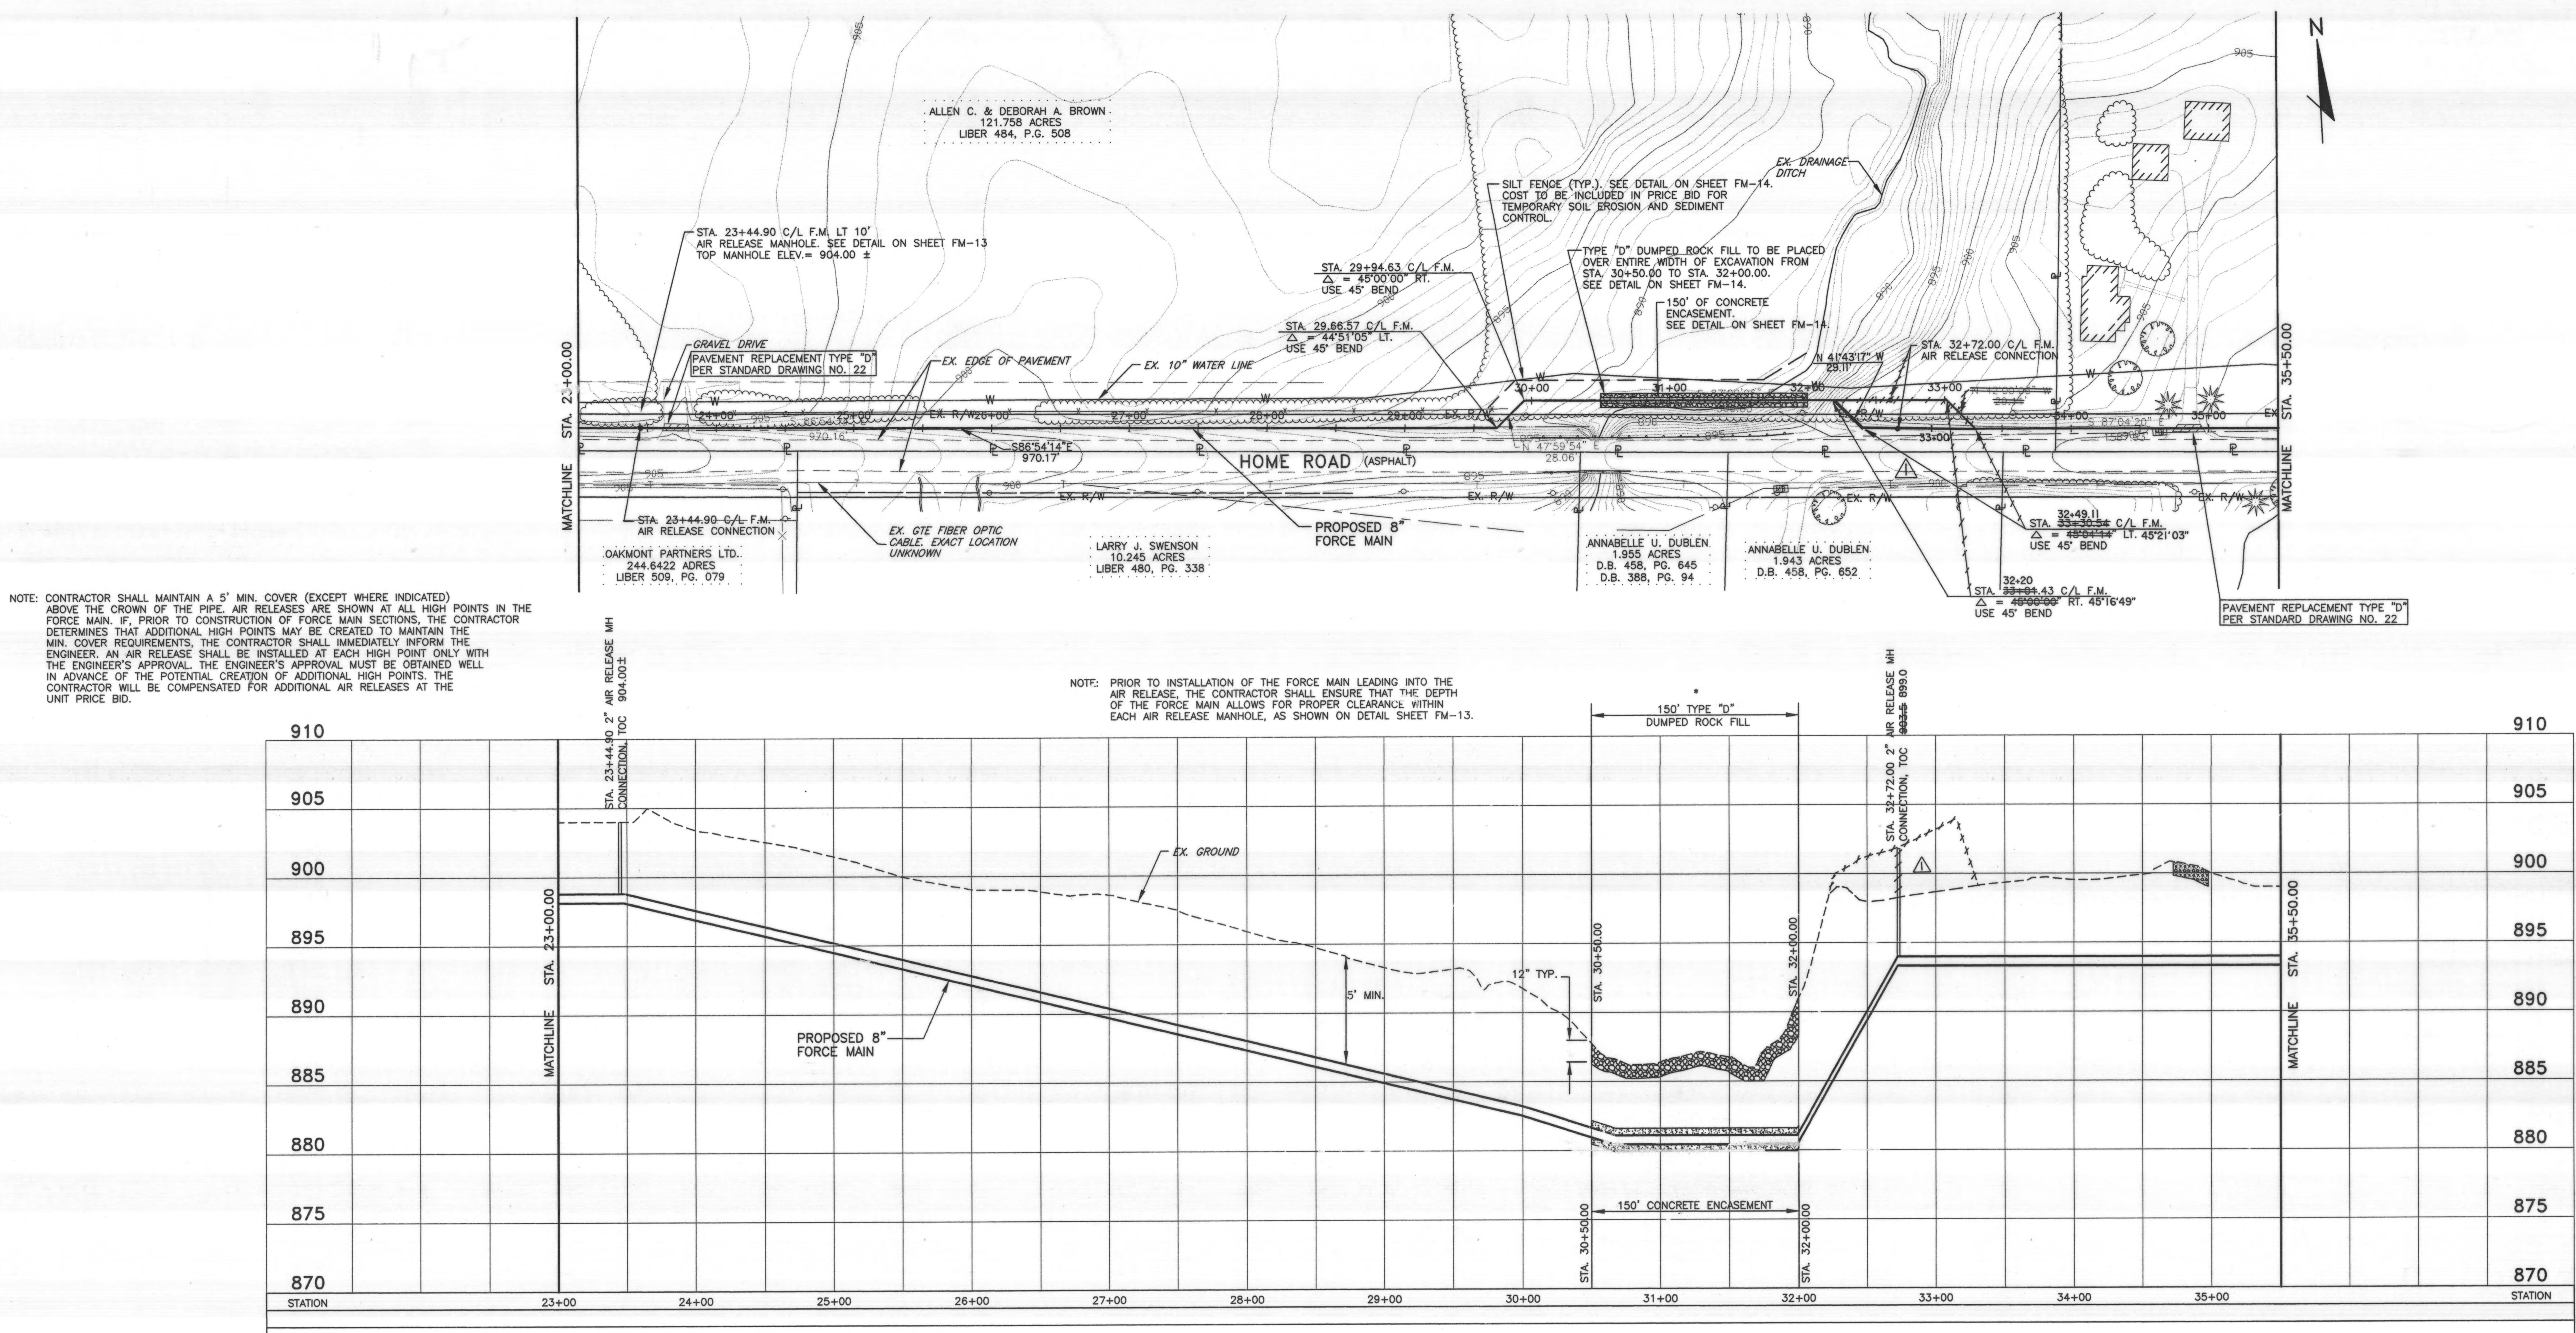

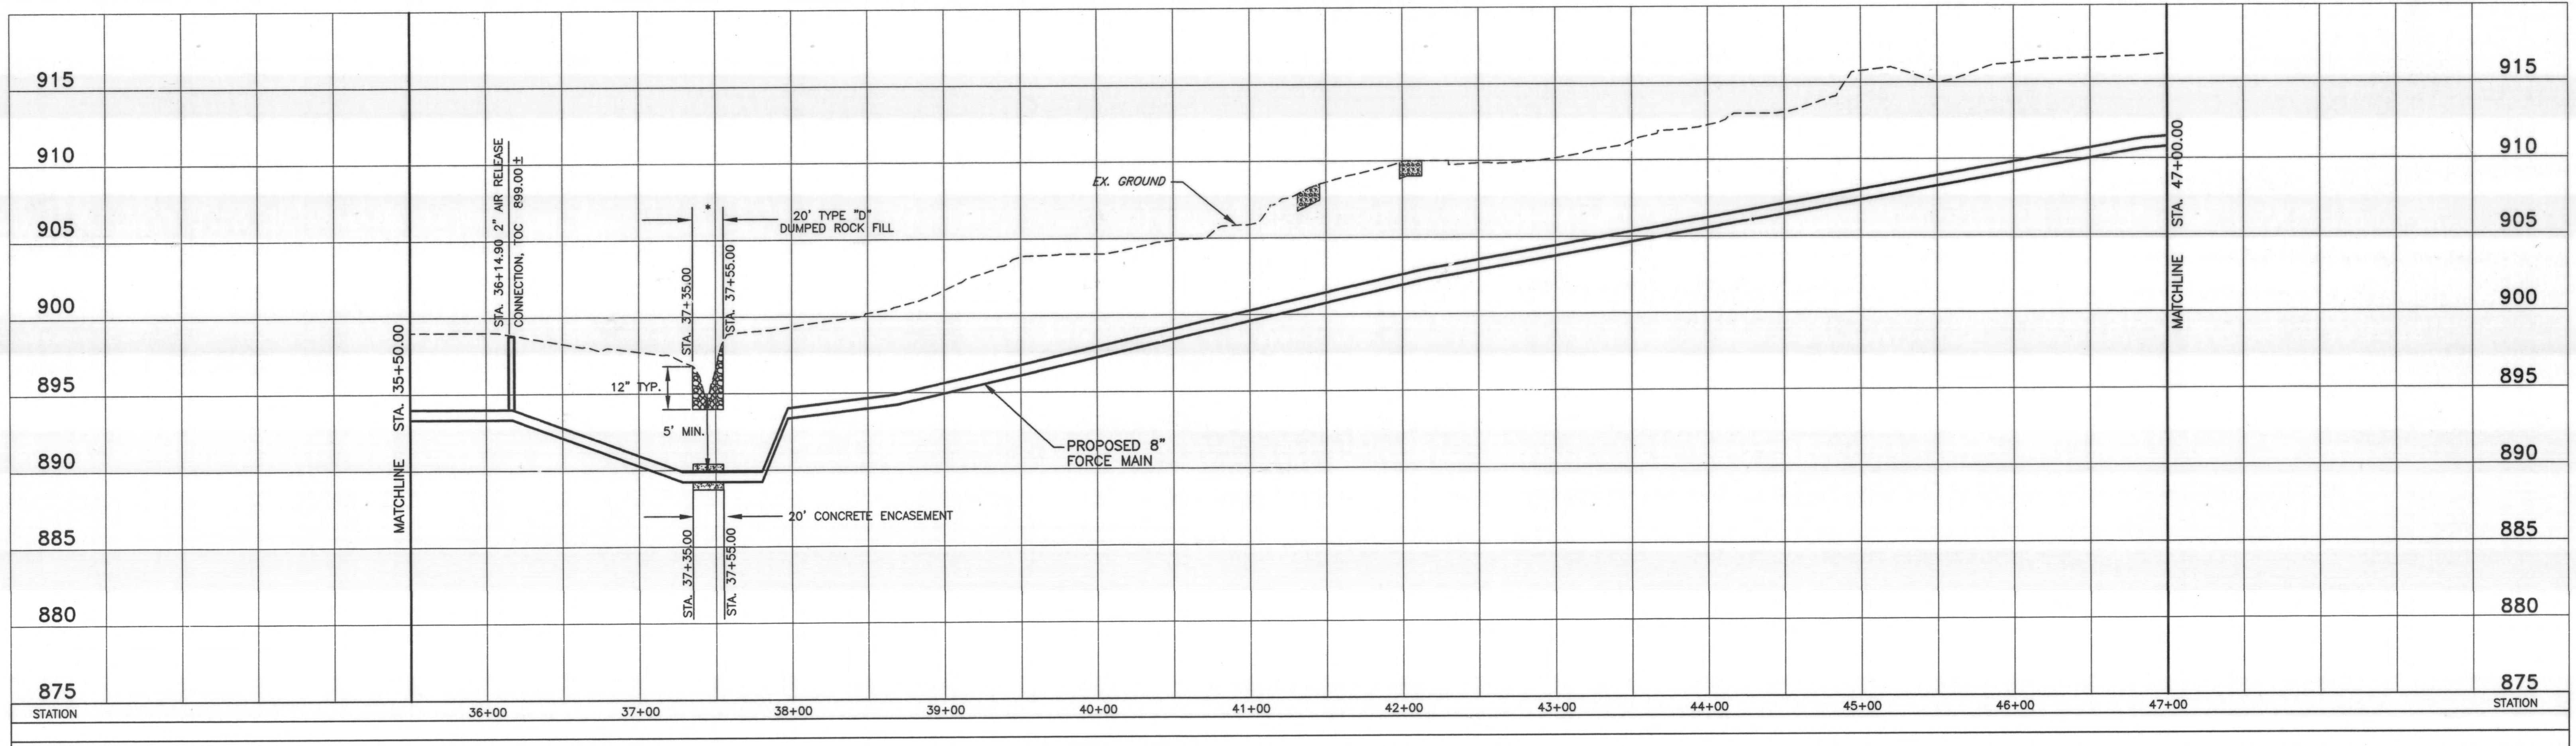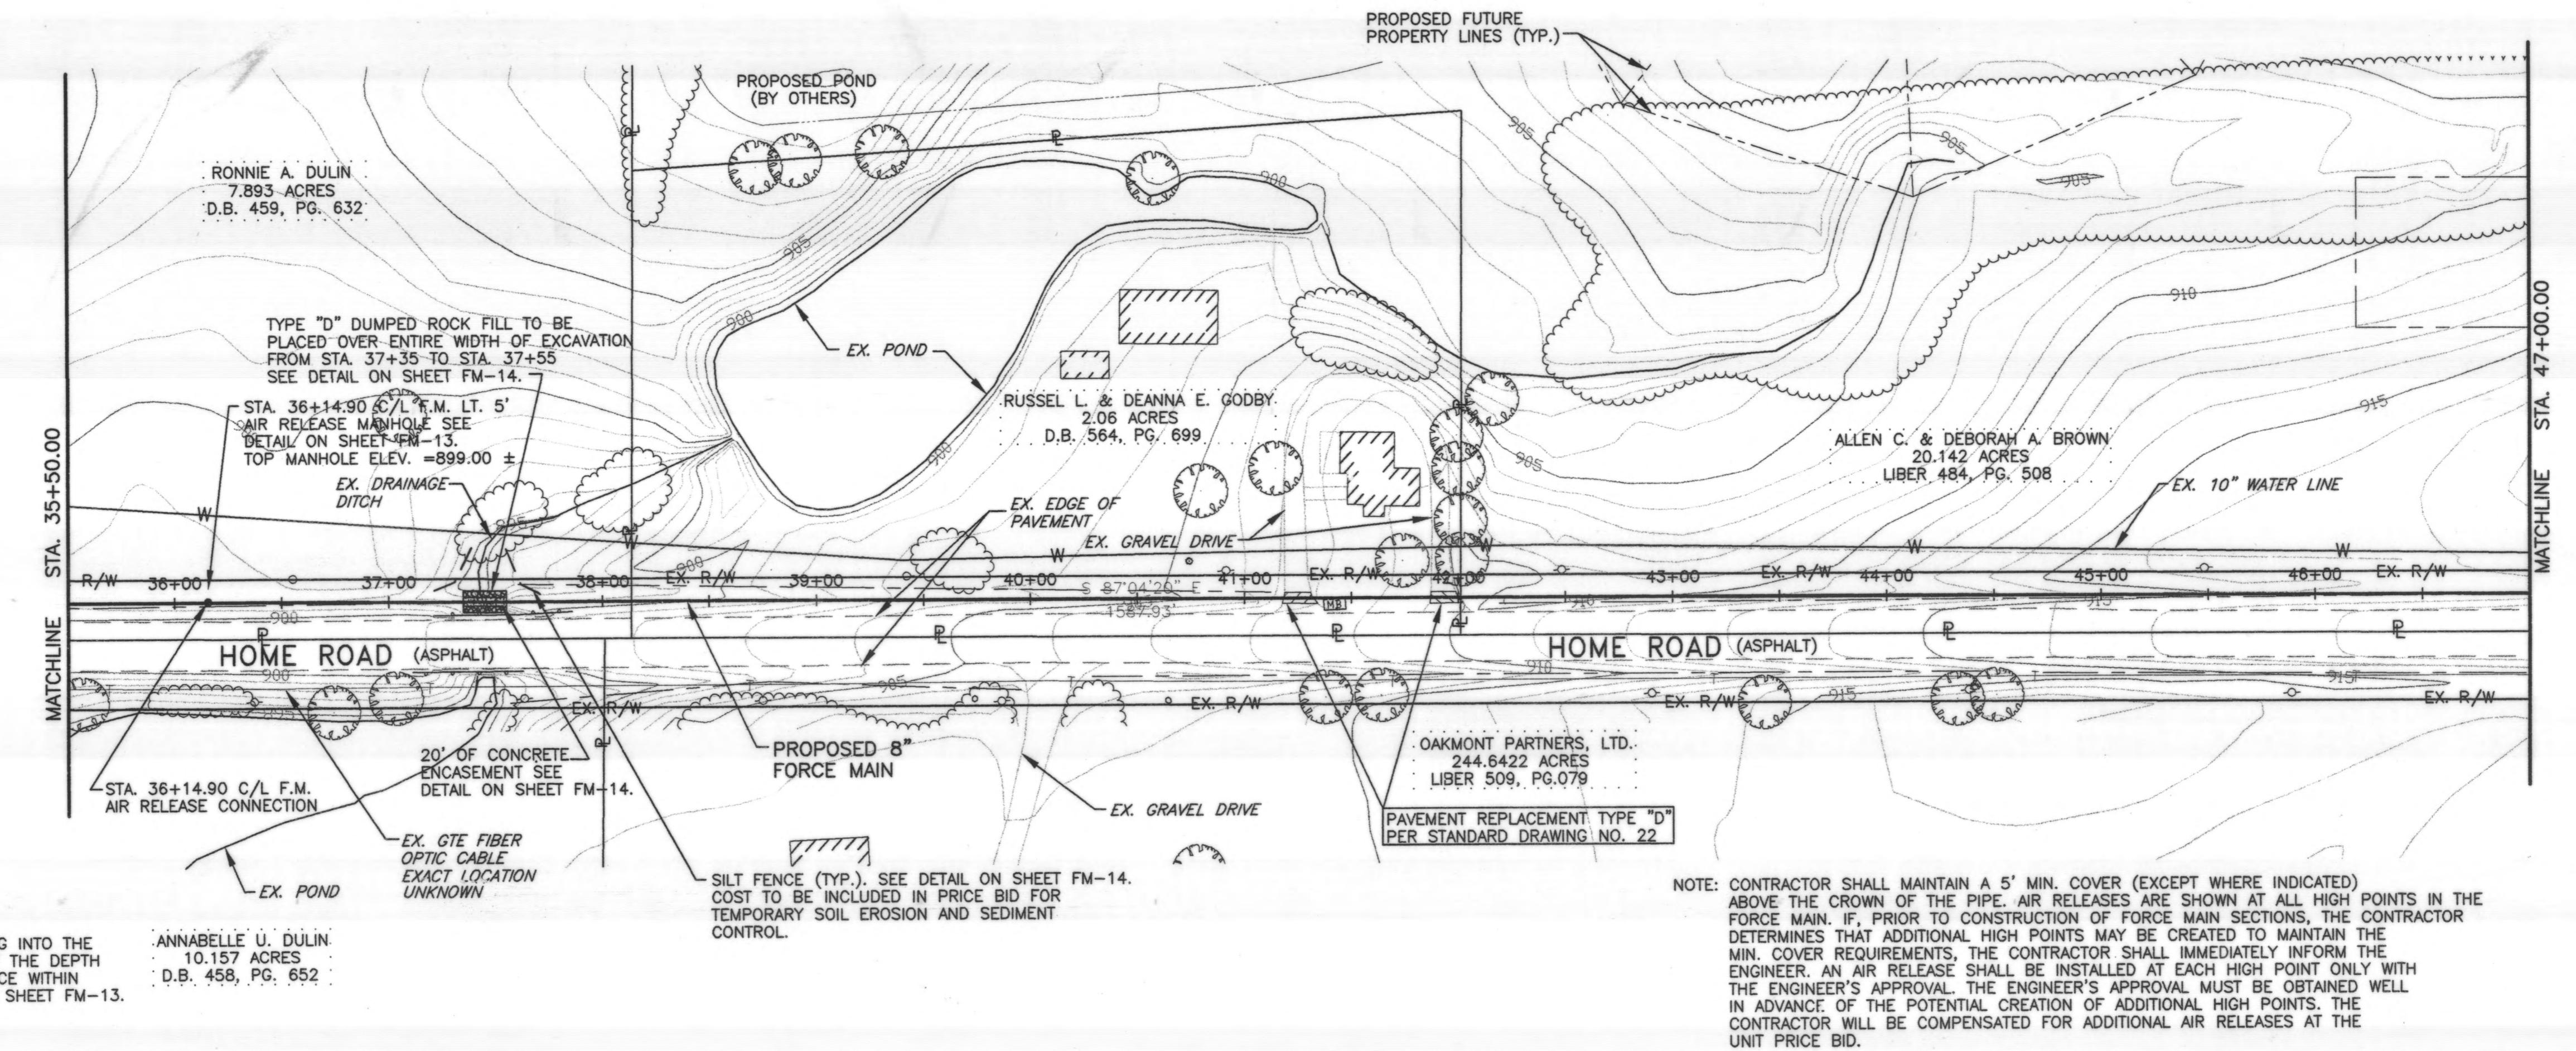


DESIGNED BY:
DRAWN BY:
CHECKED BY:
APPROVED BY:
DATE: JANUARY 25,
JOB NO. 43

REVISIONS
REMARKS

DELAY

DELAWARE COUNTY E COUNTY SANITARY ENGINE


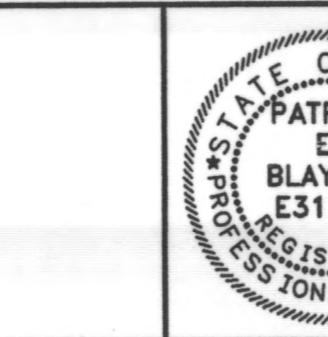


SCIOTO RESERVE
8" , 4" & 2" FORCE MAINS

SCALE


8" FORCE MAIN

SHEET NO.
FM-6

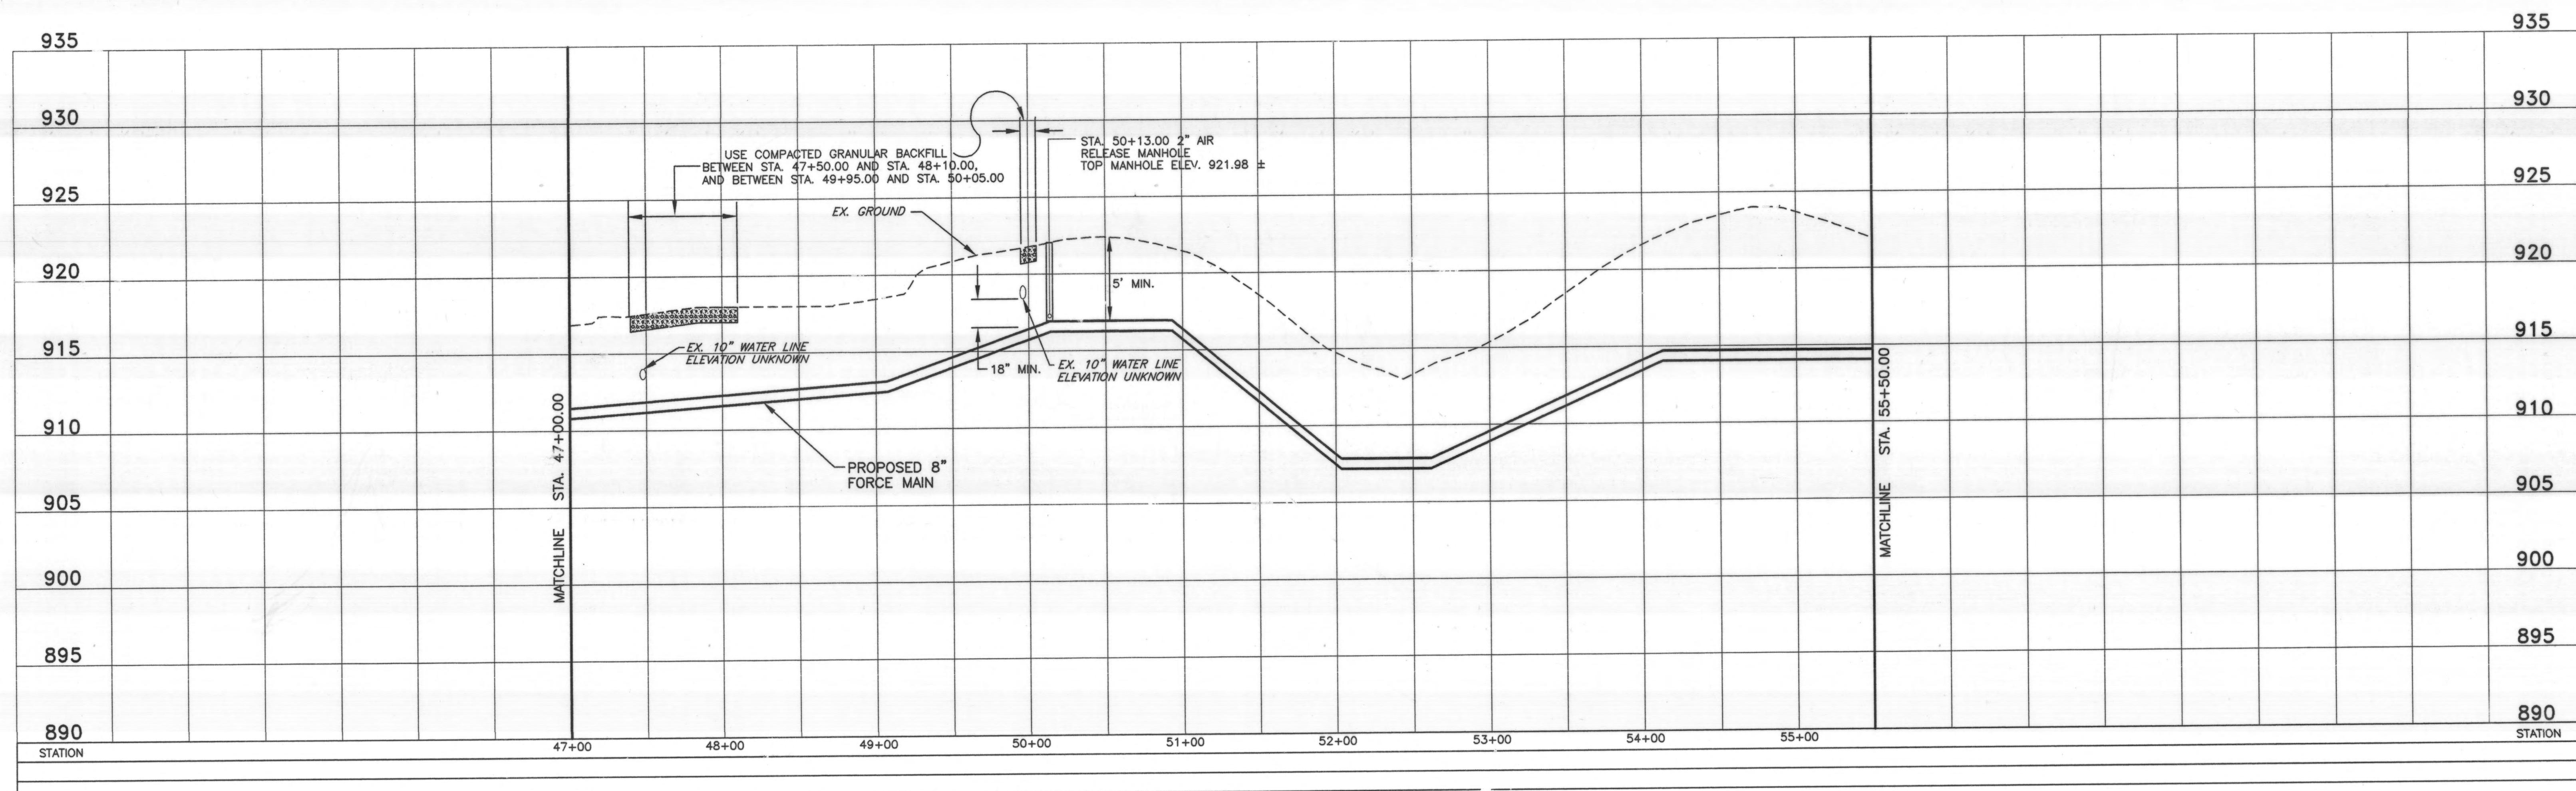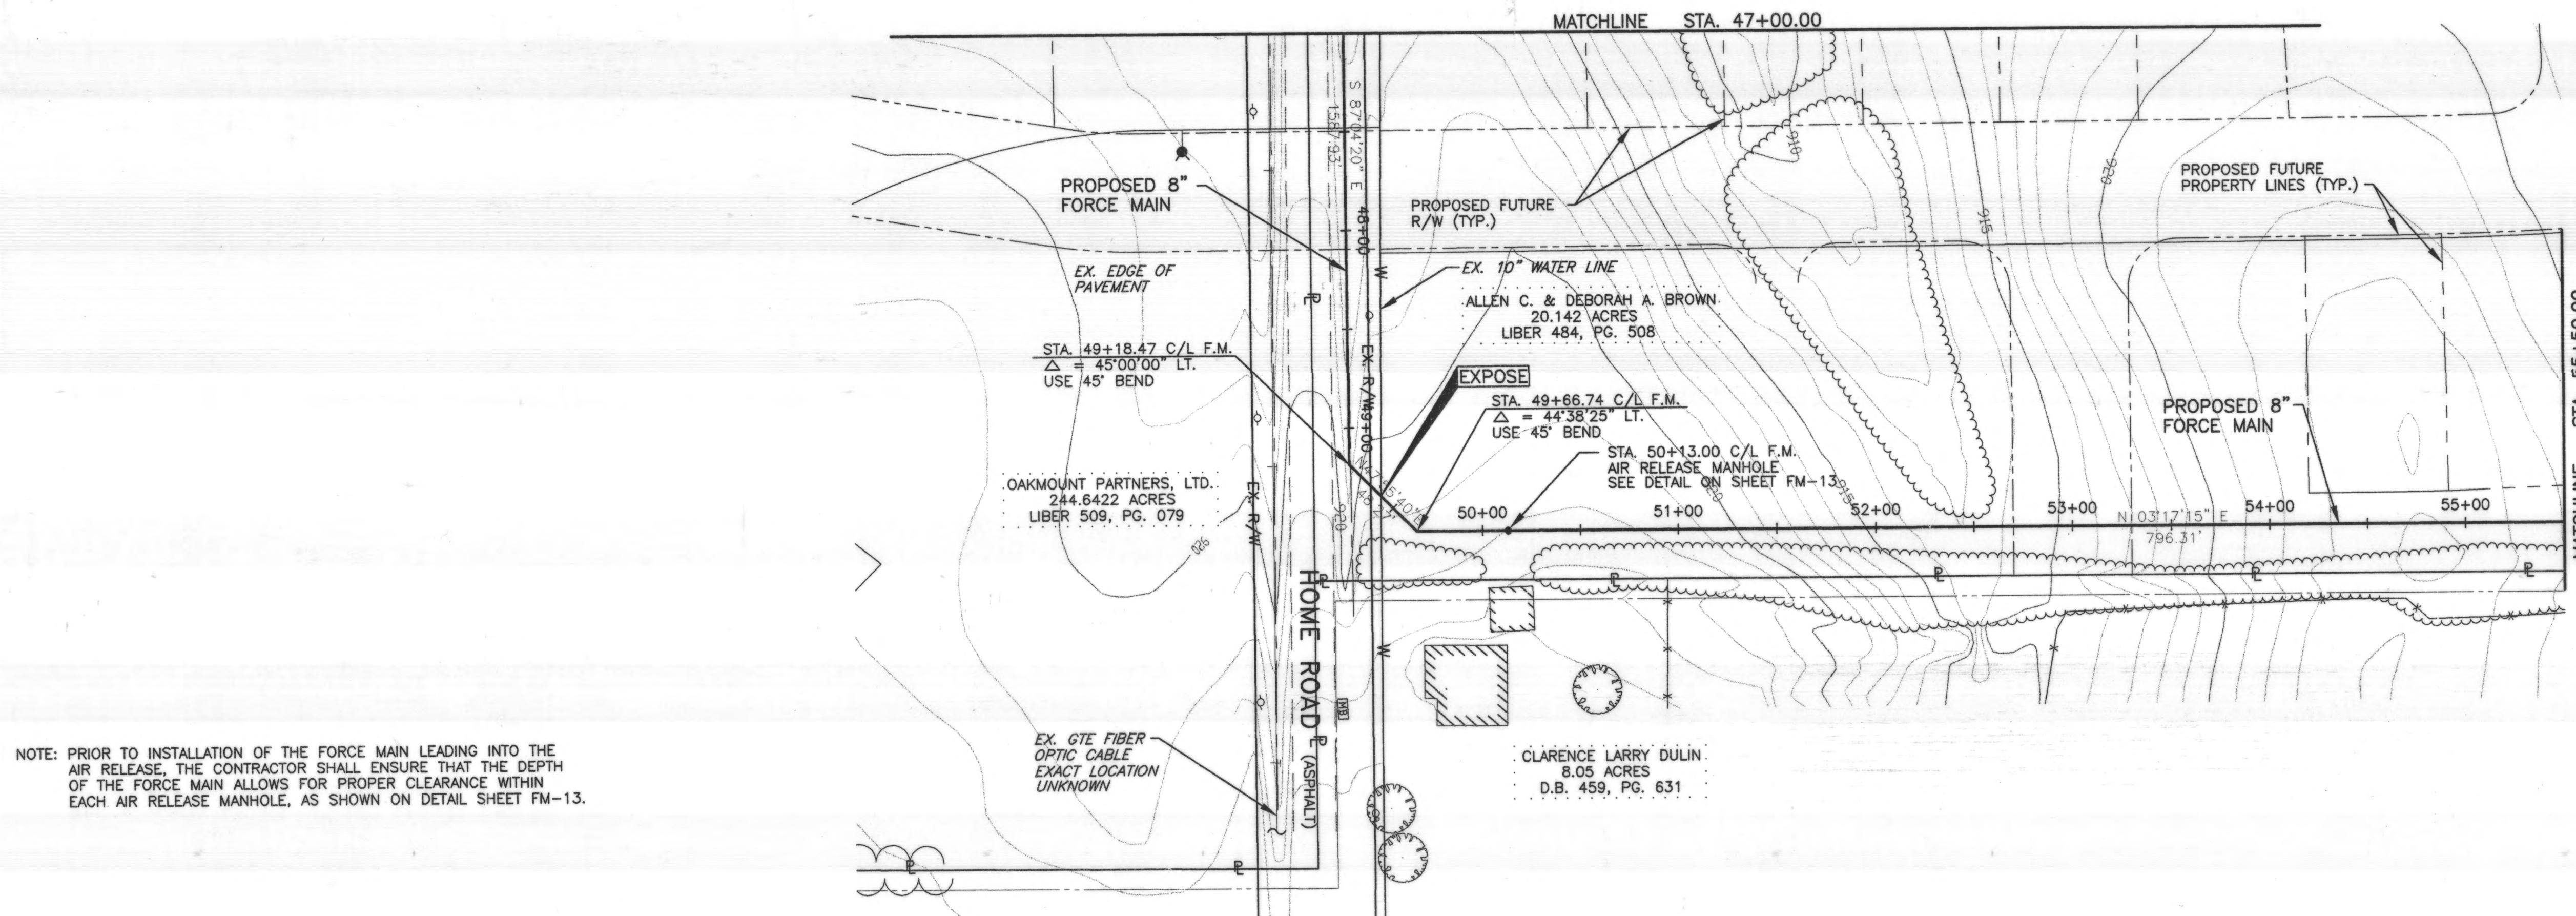

DESIGNED BY:	BGD	REVISIONS	
DRAWN BY:	ACM	DATE	
CHECKED BY:	THB	REMARKS	
APPROVED BY:	MBT		
DATE:	JANUARY 25, 1999		
JOB NO.	4363EN		

DELAWARE COUNTY
DELAWARE COUNTY SANITARY ENGINEER

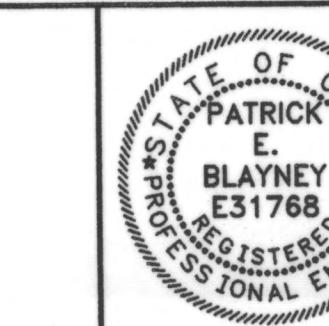


SCIOTO RESERVE
8", 4" & 2" FORCE MAINS


SCALE:
HORZ. 1"=50'
VERT. 1"=5'

8" FORCE MAIN
PLAN & PROFILE


SHEET NO.
FM-7

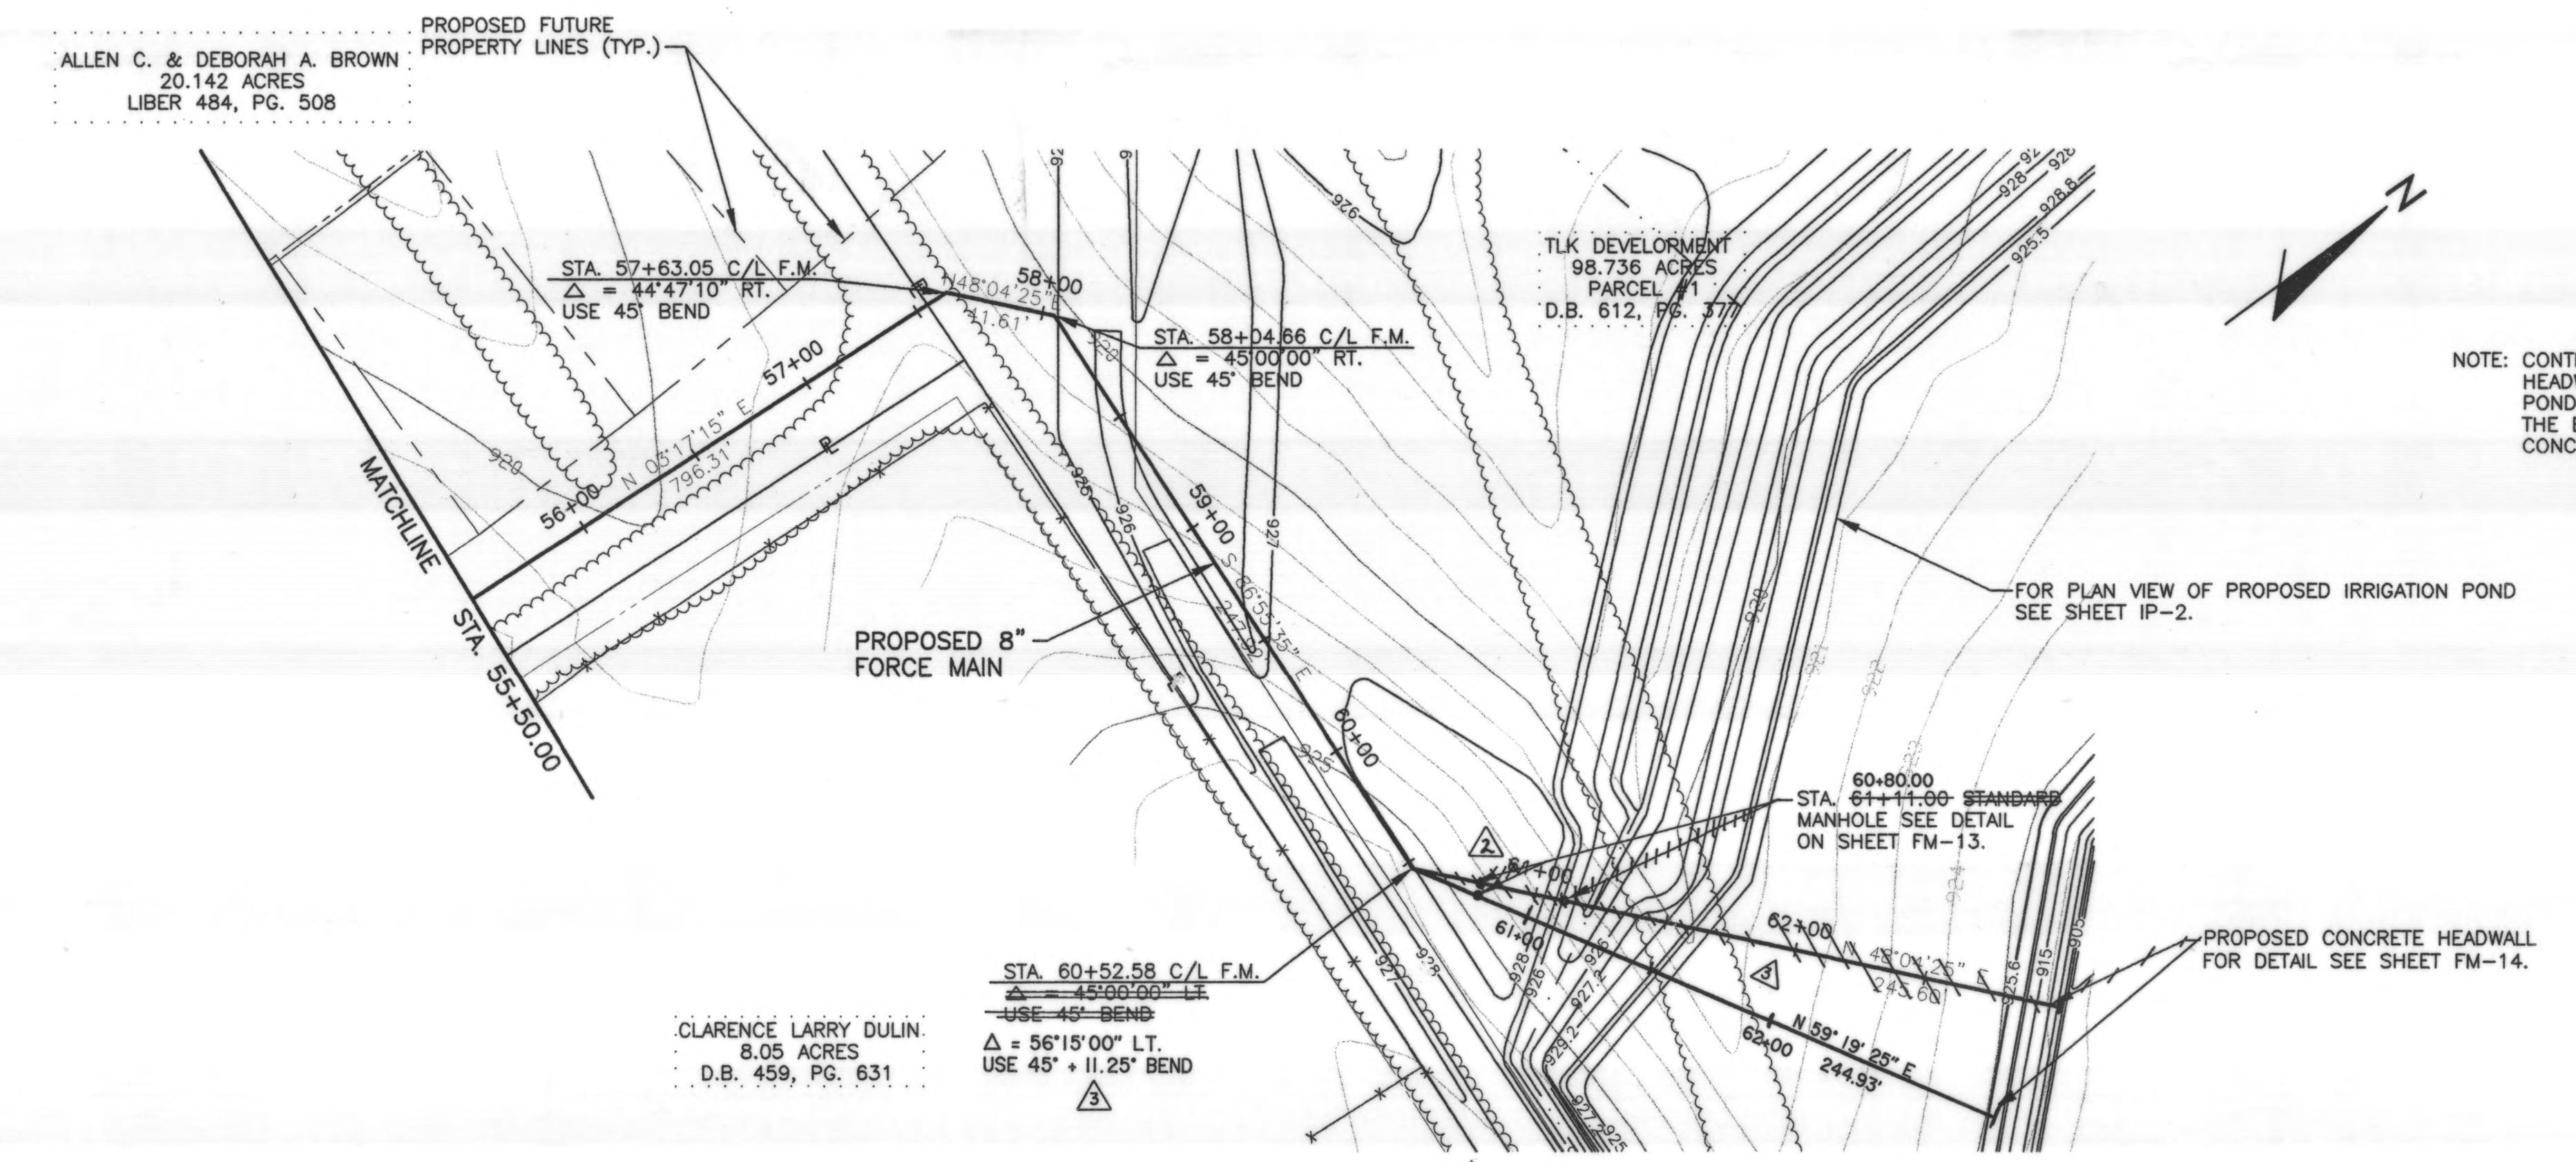


NOTE: CONTRACTOR SHALL COORDINATE FORCE MAIN AND CONCRETE HEADWALL INSTALLATION WITH CONSTRUCTION OF PROPOSED IRRIGATION POND. IF FORCE MAIN IS INSTALLED PRIOR TO IRRIGATION POND, THE END OF FORCE MAIN SHALL BE PLUGGED AND CONSTRUCTION OF CONCRETE HEADWALL SHALL BE DELAYED UNTIL POND IS BUILT.

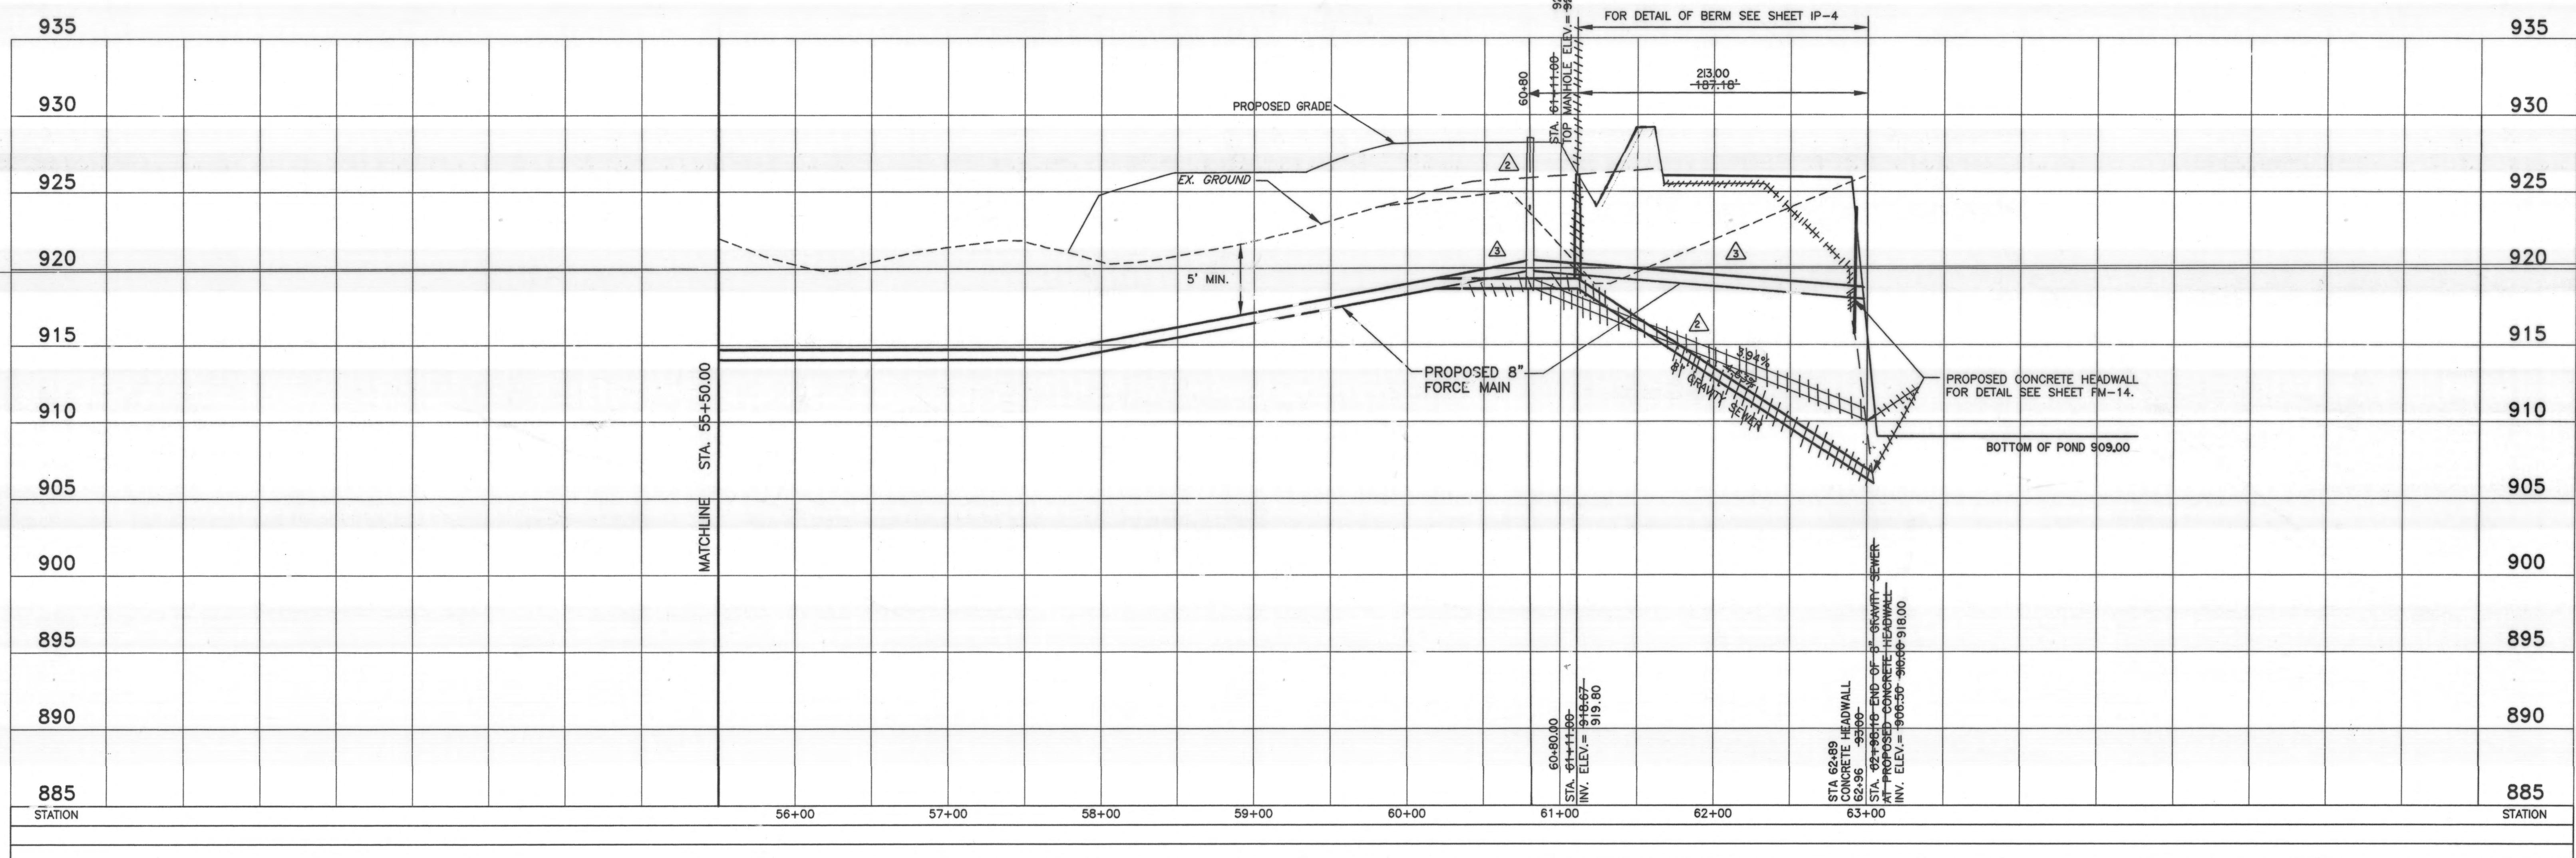

DESIGNED BY:	BGD	REVISIONS		DELAWARE COUNTY	SCIOTO RESERVE	SCALE:	8" FORCE MAIN	SHEET NO.
		DATE	REMARKS					
DRAWN BY:	ACM	8/27/99	MOVED MANHOLE LOCATION, PIPE SLOPE, PIPE INVERT ON GRAVITY SEWER.					
CHECKED BY:	THB	8/27/99	MOVED MANHOLE LOCATION, PIPE SLOPE, PIPE INVERT ON GRAVITY SEWER.					
APPROVED BY:	MBT	9/1/99	ADDED II.25° BEND, MOVED MANHOLE, END INVERT, & HEADWALL LOCATION. CHANGED RENO MATTRESS TO.					
DATE:	JANUARY 25, 1999		DUMPED ROCK FILL.					
JOB NO.	4363EN			DELAWARE COUNTY SANITARY ENGINEER	STATE OF OHIO PATRICK E. BLAYNEY E31768 REGISTERED PROFESSIONAL ENGINEER	HORZ. 1"=50' VERT. 1"=5'	FORCE MAIN PLAN & PROFILE	FM-8

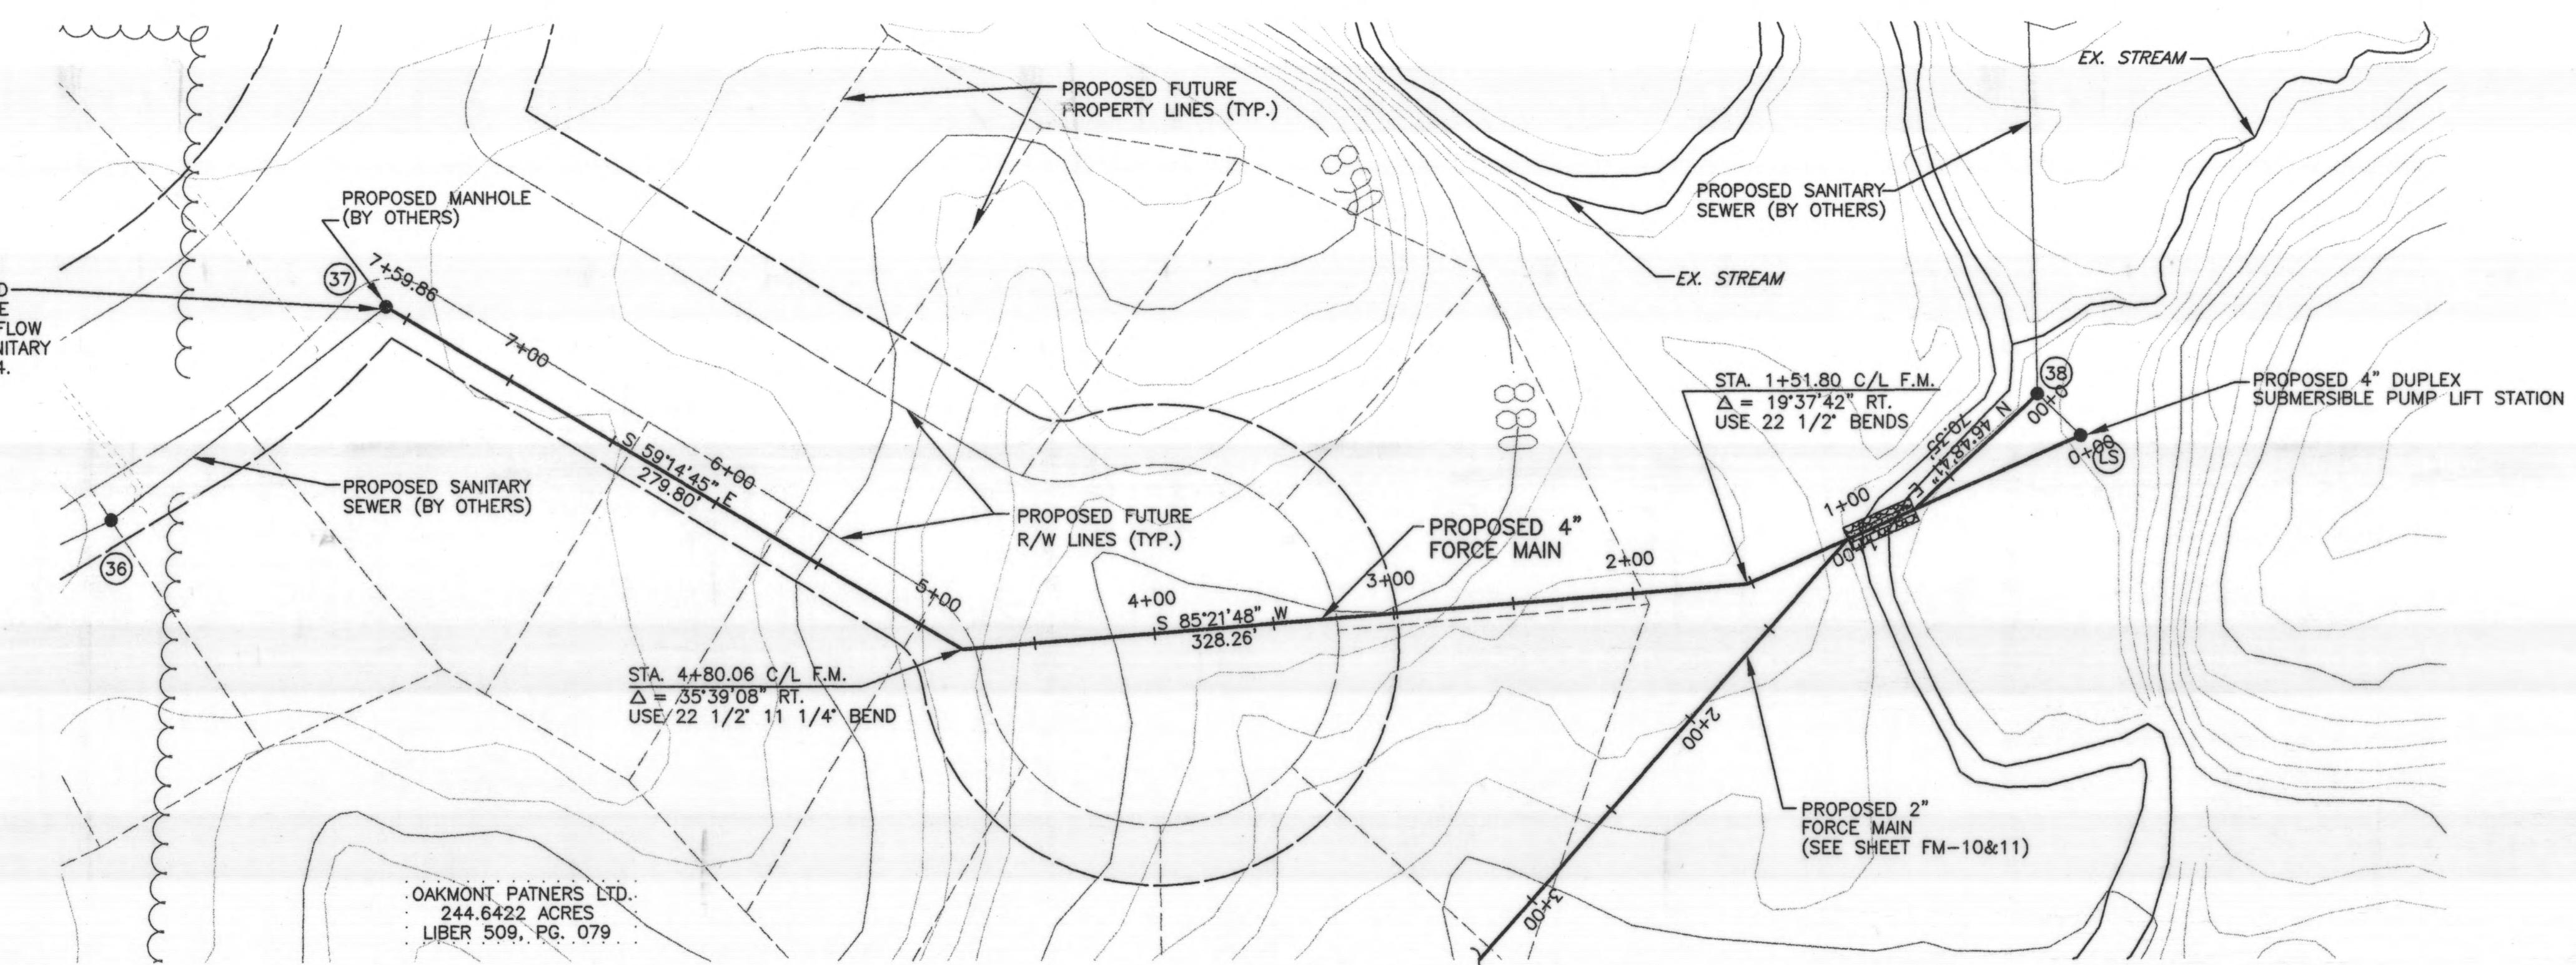


NOTE: CONTRACTOR SHALL MAINTAIN A 5' MIN. COVER (EXCEPT WHERE INDICATED) ABOVE THE CROWN OF THE PIPE. AIR RELEASES ARE SHOWN AT ALL HIGH POINTS IN THE FORCE MAIN. IF, PRIOR TO CONSTRUCTION OF FORCE MAIN SECTION, THE CONTRACTOR DETERMINES THAT ADDITIONAL HIGH POINTS MAY BE CREATED, MAINTAIN THE MIN. COVER REQUIREMENTS. THE CONTRACTOR SHALL IMMEDIATELY INFORM THE ENGINEER. AN AIR RELEASE SHALL BE INSTALLED AT EACH HIGH POINT ONLY WITH THE ENGINEER'S APPROVAL. THE ENGINEER'S APPROVAL MUST BE OBTAINED WELL IN ADVANCE OF THE POTENTIAL CREATION OF ADDITIONAL HIGH POINTS. THE CONTRACTOR WILL BE COMPENSATED FOR ADDITIONAL AIR RELEASES AT THE UNIT PRICE BID.

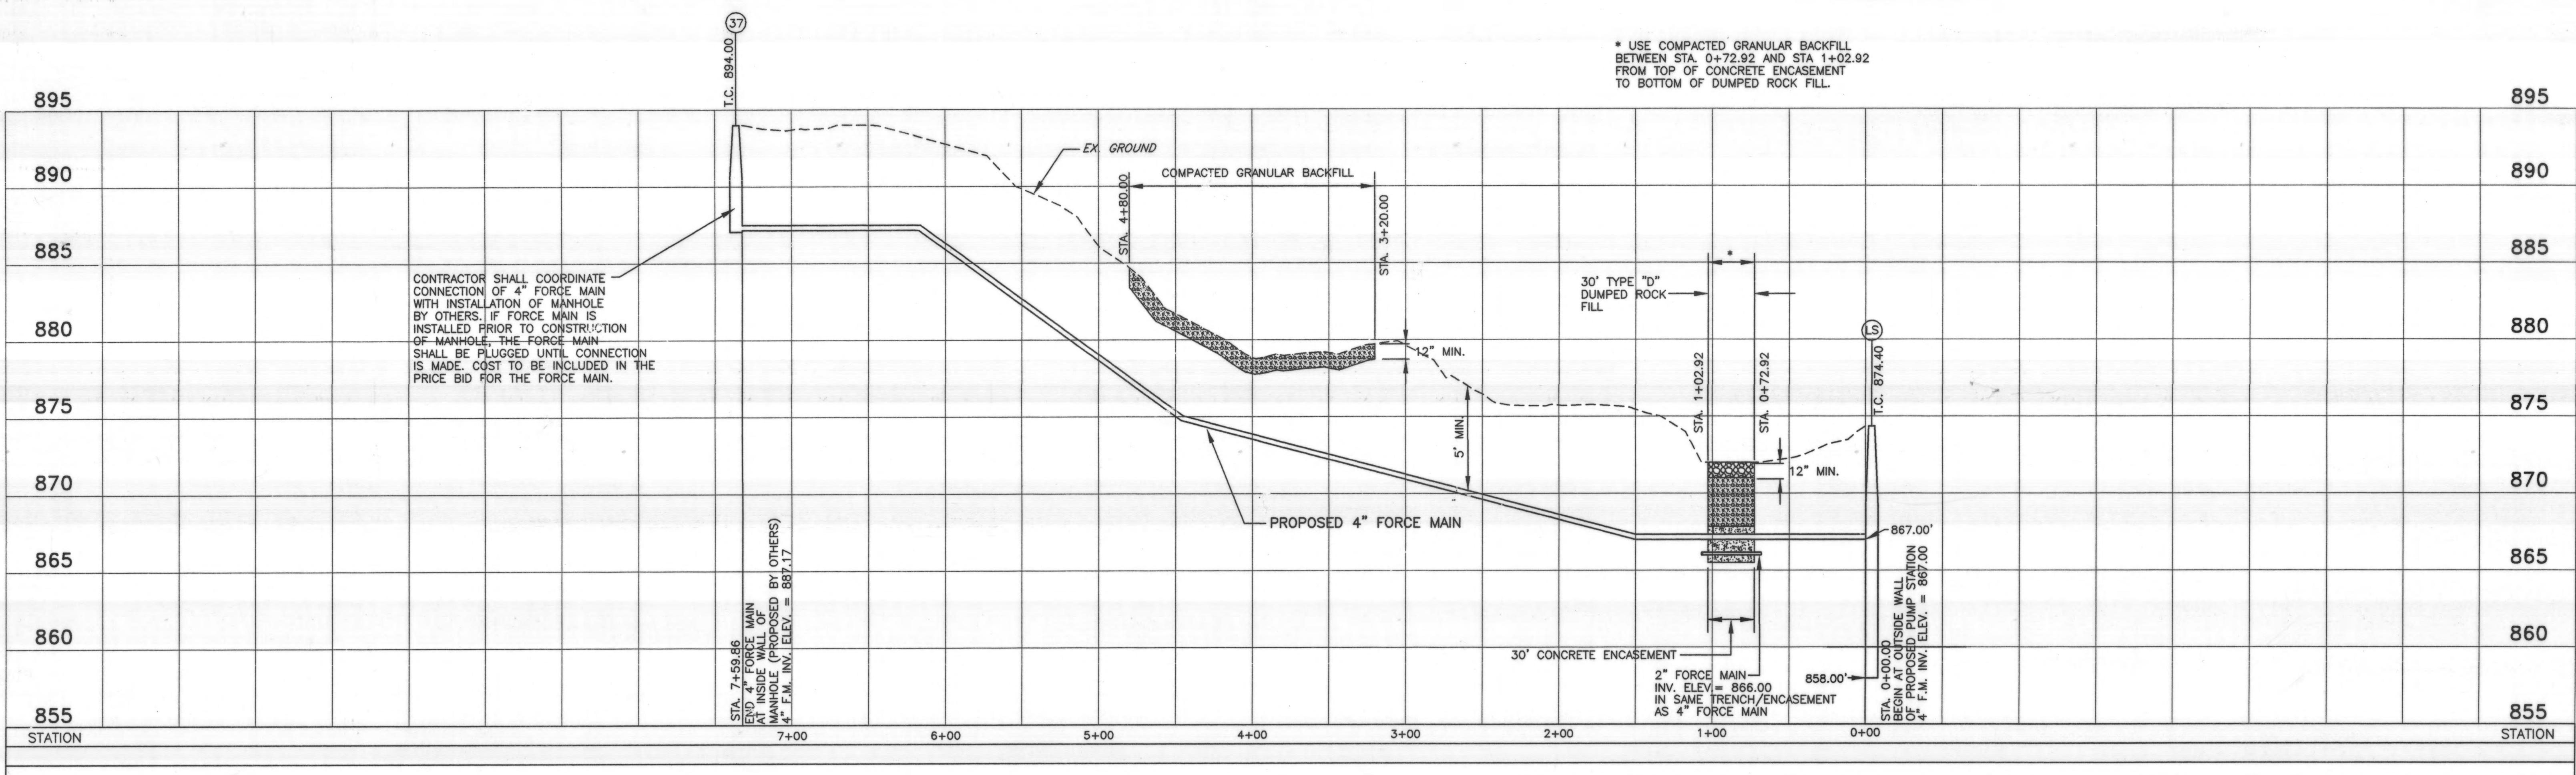


DESIGNED BY:	BGD	REVISIONS	
DRAWN BY:	ACM	DATE	REMARKS
CHECKED BY:	THB		
APPROVED BY:	MBT		
DATE:	JANUARY 25, 1999		
JOB NO.	4363EN		

DELAWARE COUNTY
DELAWARE COUNTY SANITARY ENGINEER

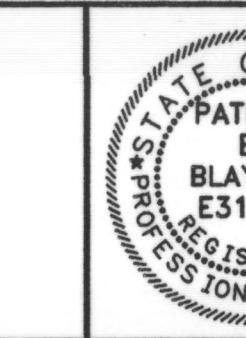

SCIOTO RESERVE
8", 4" & 2" FORCE MAINS




SCALE: HORZ. 1"=50' VERT. 1"=5'	4" FORCE MAIN	SHEET NO.
	PLAN & PROFILE	FM-9

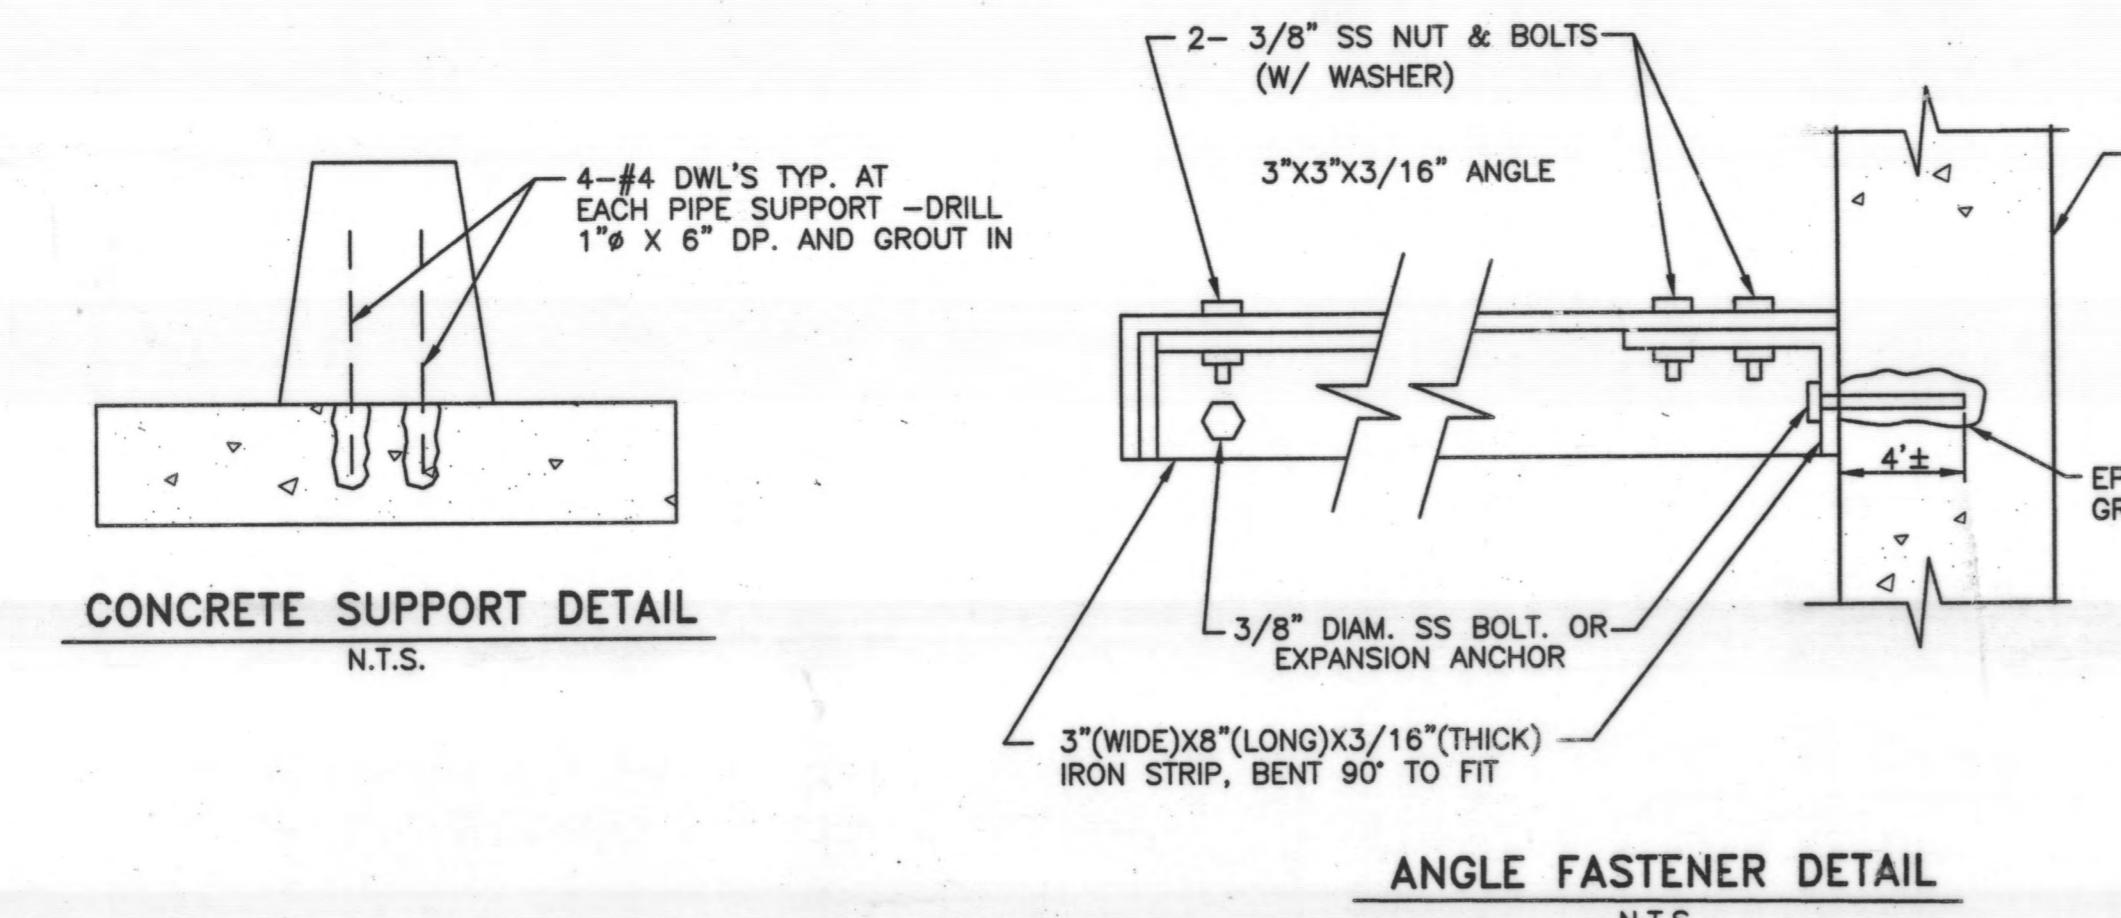


AIR RELEASE NOTES

1. AIR RELEASE DETAILS SHALL BE USED IN CONJUNCTION WITH THE DELAWARE COUNTY STANDARD PLANS AND SPECIFICATIONS FOR CONSTRUCTION OF SANITARY FACILITIES.
2. 36" OPENINGS IN THE AIR RELEASE HOLES SHALL BE OFFSET FROM THE CENTERLINE OF THE MANHOLE TO ALLOW FOR ACCESS BY MAINTENANCE PERSONNEL. THE DISTANCE OFFSET SHALL BE APPROVED BY THE ENGINEER PRIOR TO THE ORDERING OF MANHOLES.

ANGLE FASTENER DETAIL
N.T.S.

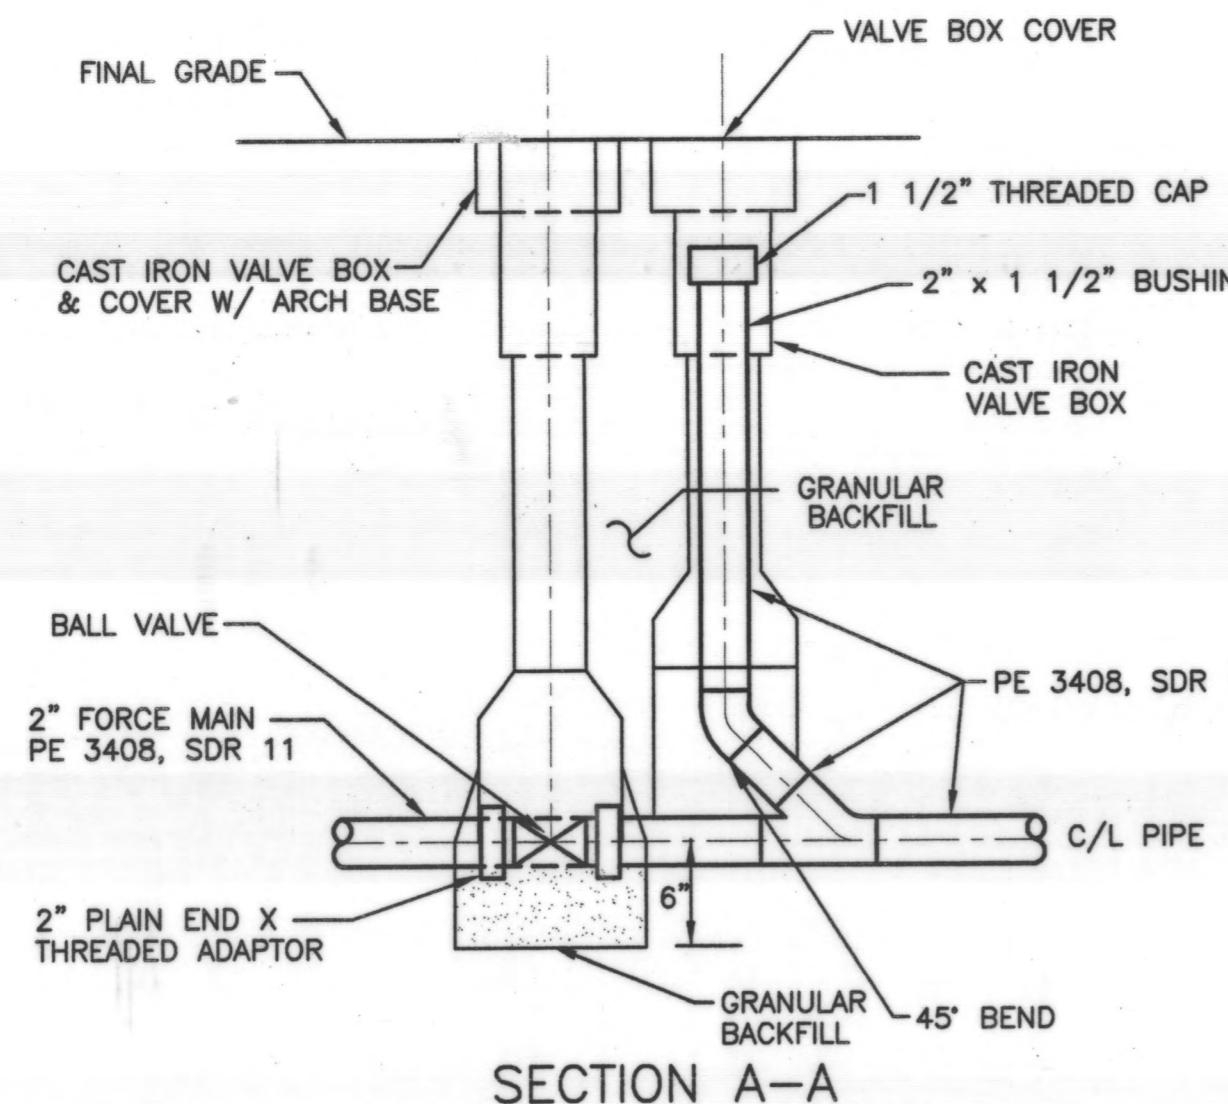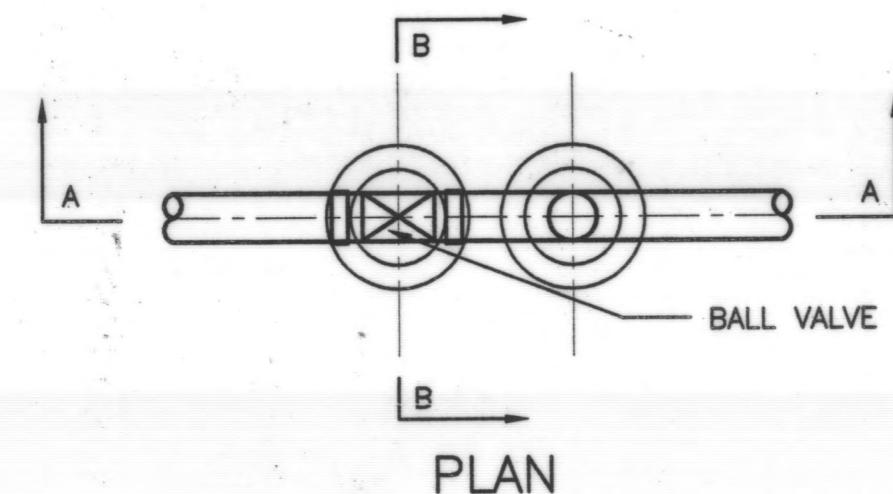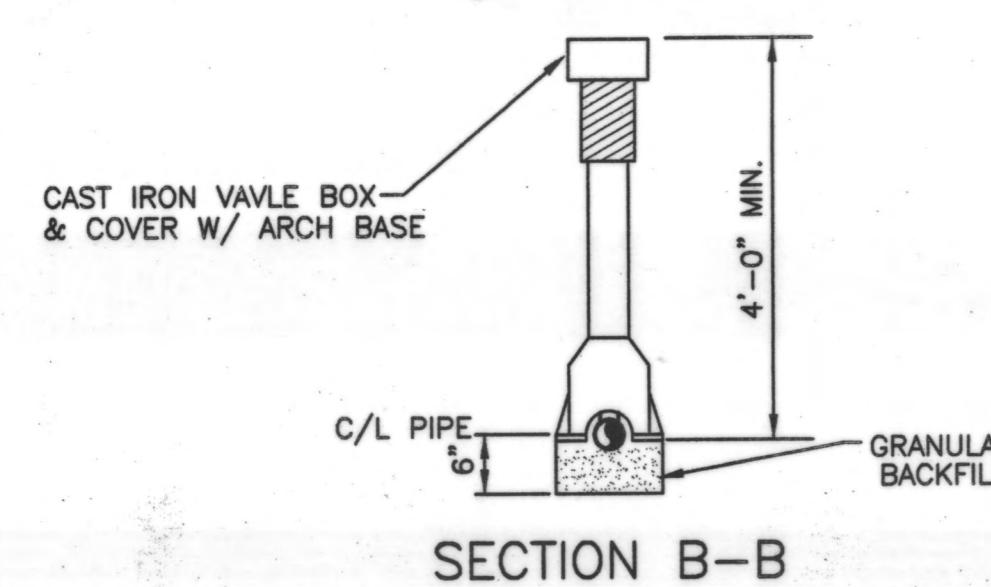


IN-LINE VALVE BOX AND FLUSHOUT
N.T.S.

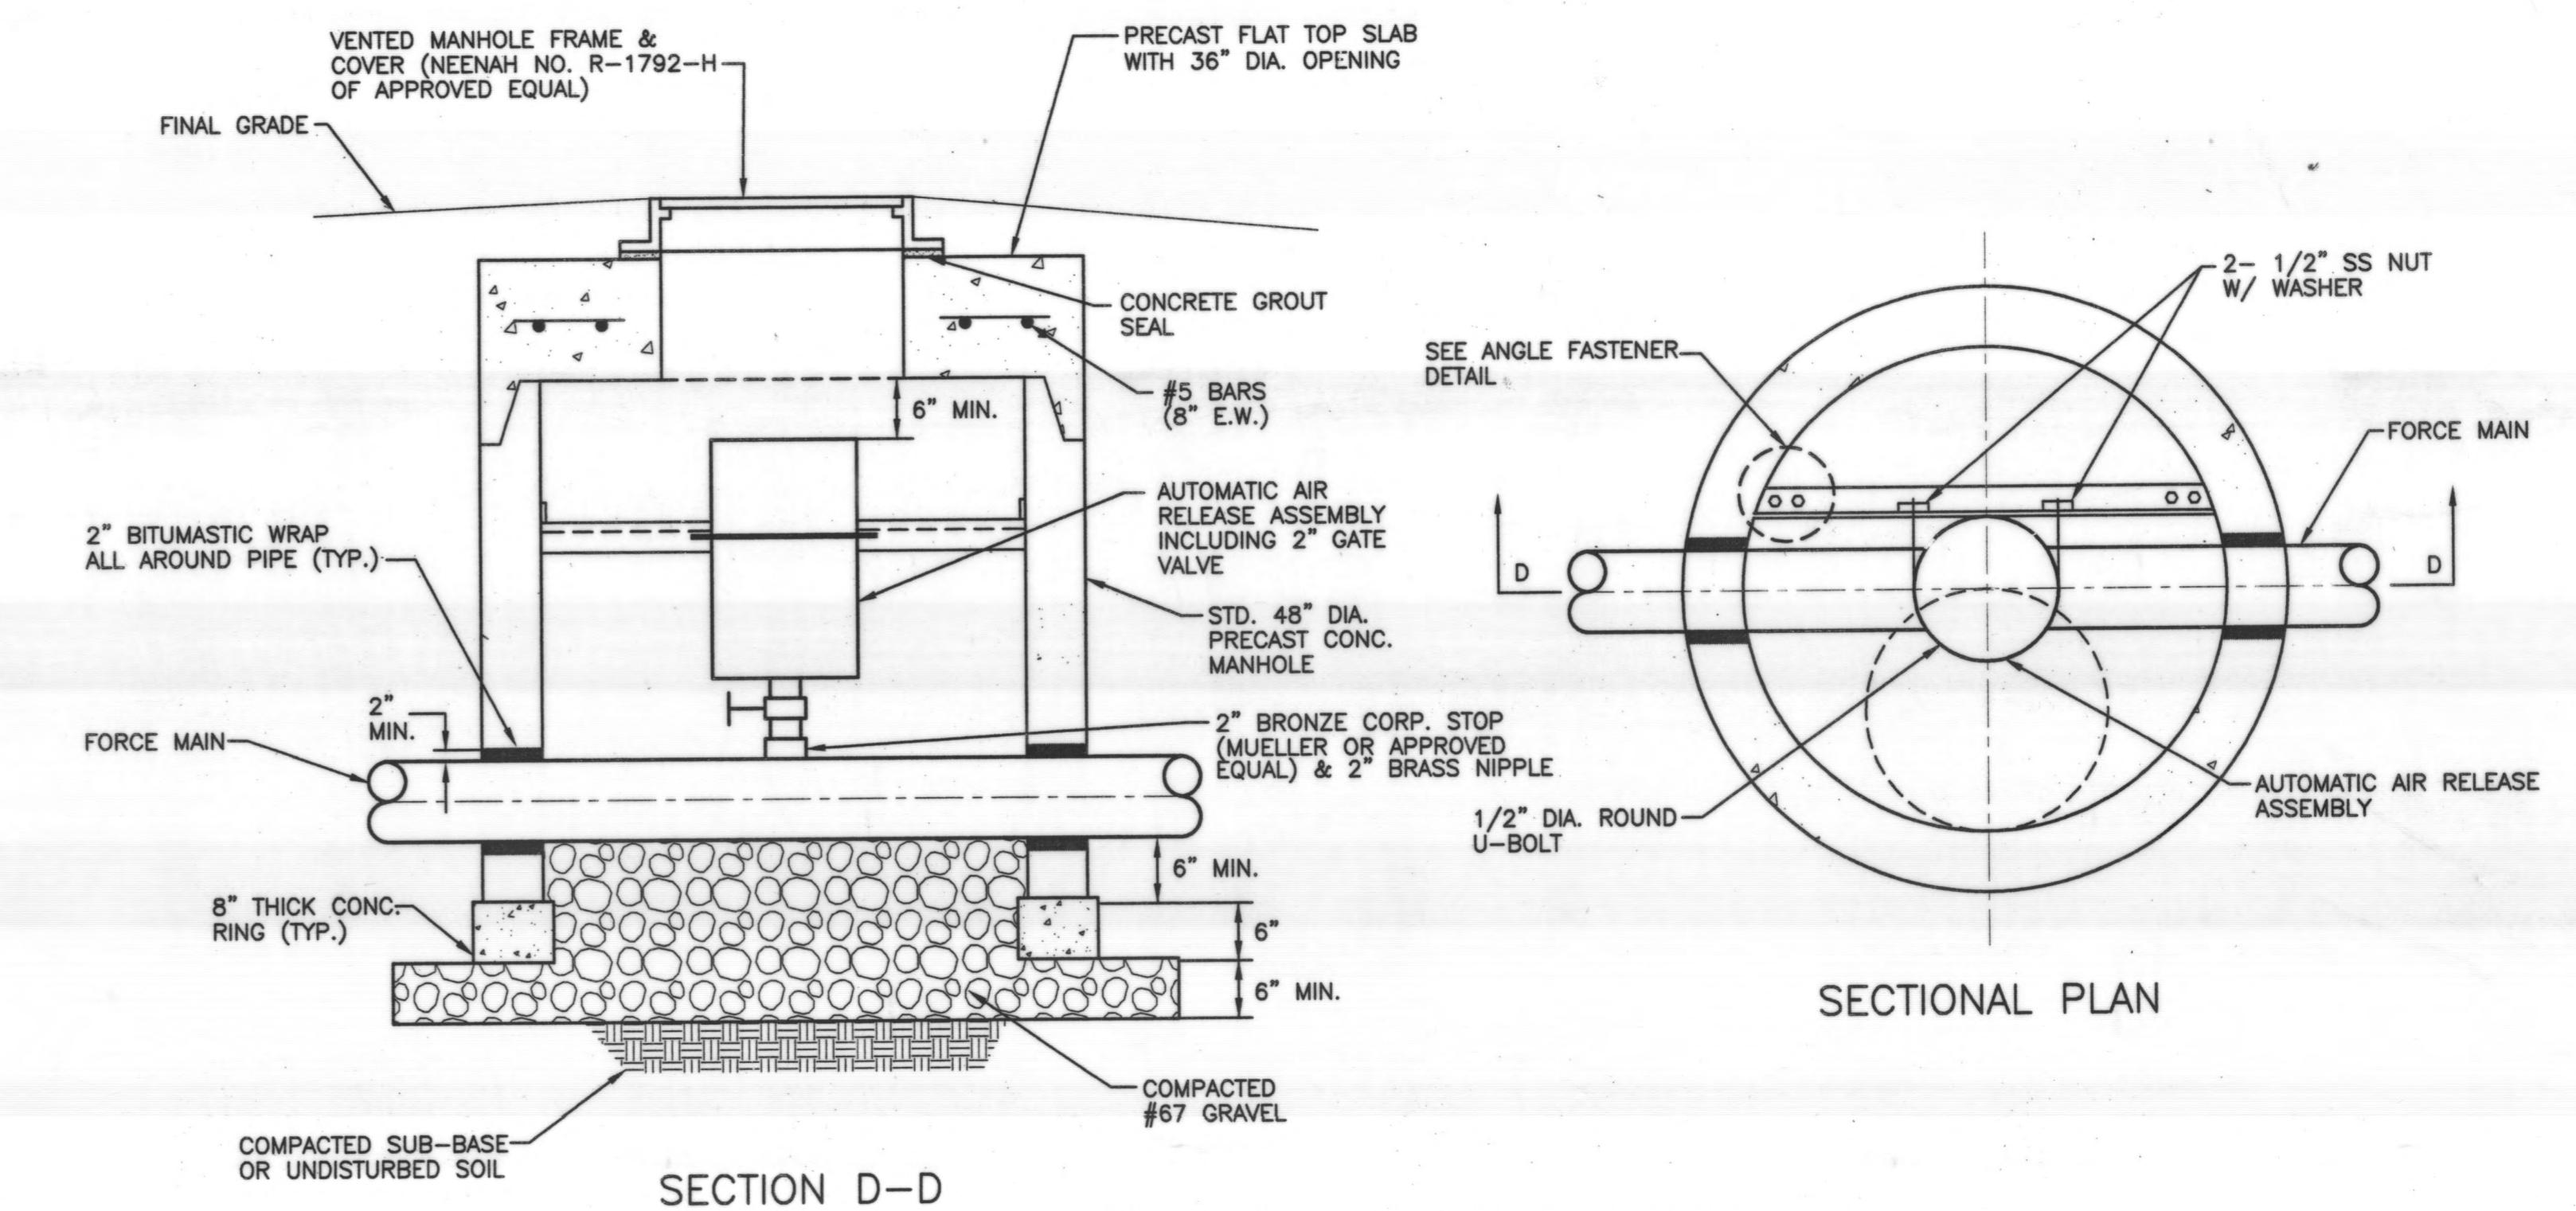

AIR RELEASE MANHOLE DETAIL
N.T.S.

DESIGNED BY:	BGD	REVISIONS	
DRAWN BY:	ACM	DATE	
CHECKED BY:	THB	REMARKS	
APPROVED BY:	MBT		
DATE:	JANUARY 25, 1999		
JOB NO.	4363EN		

DELAWARE COUNTY
DELAWARE COUNTY SANITARY ENGINEER

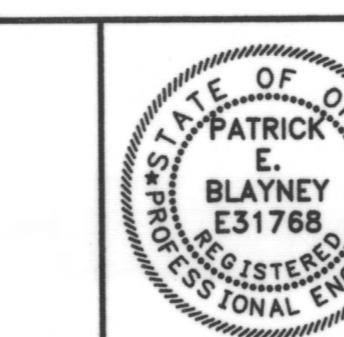

SCIOTO RESERVE
8", 4" & 2" FORCE MAINS

SCALE:	GENERAL	SHEET NO.
NOT TO SCALE	DETAILS	FM-13

STREAM MITIGATIVE MEASURES

CONTRACTOR SHALL GIVE SPECIAL ATTENTION TO PROPER SEWER CONSTRUCTION, PROTECTION OF THE STREAM AND RIPARIAN AREAS, AND THE MITIGATIVE MEASURE NOTES, SHOWN BELOW AS WELL AS THOSE ON THE DRAWINGS AND STATED IN THE SPECIFICATIONS. FAILURE TO CONFORM TO THESE NOTES WILL RESULT IN PENALTIES INCLUDING PAYMENT WITHHOLDING UNTIL COMPLIANCE WITH NOTES REMEDIATION HAS BEEN COMPLETED.

THE CONTRACTOR SHALL CONFORM TO THE FOLLOWING REQUIREMENTS WHEN CONSTRUCTION OF THE SEWER IS WITHIN THE STREAM BANKS. THESE MEASURES ARE BEING TAKEN SO THAT THE STREAM CAN BE RESTORED TO THE "BEFORE CONSTRUCTION" CONDITIONS.

- A. STREAM AREA CONSTRUCTION SHALL BE INITIATED AND COMPLETED DURING NORMAL TO LOW FLOW PERIODS AND WITHIN THE SAME DAY.
- B. TEMPORARY DIVERSION OF STREAM FLOW AROUND CONSTRUCTION AREA WILL BE PERMITTED PROVIDED THE METHOD TO BE USED RECEIVED PRIOR APPROVAL BY GREENE COUNTY AND ANY DISTURBANCE TO THE STREAM IS MINIMIZED. DISTURBED AREAS SHALL BE IMMEDIATELY RESTORED USING THE PROPER MITIGATIVE MEASURES.
- C. STOCKPILE EXISTING STREAM BOTTOM MATERIAL FOR A MINIMUM DEPTH OF 12" PRIOR TO EXCAVATION OF TRENCH. STOCKPILE IN AREAS THAT DO NOT INCREASE DAMAGE TO THE STREAM AND WILL NOT BE SUBJECT TO REMOVAL BY HIGH STREAM FLOWS AND NOT DAMAGE THE RIPARIAN VEGETATION.
- D. DEPOSIT EXCAVATED TRENCH MATERIAL WITHIN CONSTRUCTION AREA AND PROTECTED FROM STREAM FLOW OR OUTSIDE STREAM AREA.
- E. WHERE THE TRENCH CROSSES A STREAM WITH A SOLID OR LAYERED ROCK BOTTOM, THE CONTRACTOR SHALL SAWCUT THE TRENCH EDGES TO A MINIMUM DEPTH OF 4 INCHES. THE TRENCH SHALL BE BACKFILLED WITH CONCRETE ENCASEMENT AS INDICATED IN THE STREAM CROSSING DETAIL. THE CONTRACTOR SHALL ALSO PROVIDE NECESSARY MEANS TO PREVENT FRACTURING OF THE BEDROCK DUE TO EQUIPMENT CROSSINGS.
- F. IMMEDIATELY FOLLOWING INSTALLATION OF SEWER, REPLACE STREAM BOTTOM MATERIAL IN A REASONABLY SIMILAR MANNER AS THAT OF PRE-CONSTRUCTION. CONSTRUCT AND MAINTAIN PRE-CONSTRUCTION STREAM BED SLOPE.
- G. STREAM BANK RESTORATION OR ROCK CHANNEL PROTECTION SHALL BE USED WHEN THE EXCAVATION OF THE SEWER DISTURBS THE STREAM BANK AS SHOWN ON THE DRAWINGS OR AS DIRECTED BY THE ENGINEER. THE LIMITS OF CONSTRUCTION SHALL BE AS SHOWN ON THE DRAWINGS.
- H. AT STREAM CROSSINGS, DO NOT DISTURB THE VEGETATION WITHIN THE CONSTRUCTION EASEMENT EXCEPT FOR THE AREA REQUIRED FOR EXCAVATION AND EQUIPMENT PASSAGE. THIS STREAM CROSSING AREA SHALL INCLUDE THE STREAM AND THE STREAM BANKS.
- I. SEE SPECIFIC NOTES ON THE DRAWINGS FOR OTHER CONSIDERATIONS.

DURING HIGH STREAM FLOW PERIODS, CONSTRUCTION WORK IN THE STREAM IS PROHIBITED. CONSTRUCTION OF SEWER SEGMENTS IN AREAS AWAY FROM THE STREAM WILL BE PERMITTED. CONTRACTOR MUST VERIFY SEWER SLOPES FOR CONFORMANCE WITH THE DRAWINGS AND INSTALLED SEGMENTS IN THESE AREAS.

OPERATION OF EQUIPMENT WITHIN THE STREAM BANKS SHALL NOT BE PERMITTED, EXCEPT DURING ACTUAL SEWER INSTALLATION. THE CONTRACTOR SHALL NOT CONSTRUCT ROAD ROADS THROUGH STREAM UNLESS PRIOR APPROVAL IS GRANTED BY THE ENGINEER. IF IT IS NECESSARY TO HAVE HALL ROADS CROSS THE STREAM, THE CONTRACTOR SHALL PLACEMENT OF TREES AND RELocate FROM OTHER LOCATIONS OF THE PROJECT LAD LENGTHS IN THE STREAM, OR OTHER PRE-APPROVED METHODS SHALL BE CONSTRUCTED TO AVOID CONTINUOUS STREAM IMPACTS. LIMIT CLEARING WITHIN THE EASEMENT TO THE MINIMUM AREA REQUIRED FOR THE PERFORMANCE OF THE WORK.

PROVIDE AND MAINTAIN EROSION PROTECTION USING STRAW BALES OR SILT FENCING ALONG CLEARED SLOPING AREAS, EXPOSED SOILS WITHIN 25 FEET OF TOP OF STREAM BANK, STREAM CROSSING SITES, AND ANY OTHER EROSION PRONE AREA.

WHEN CONSTRUCTION IS ADJACENT TO THE STREAM, MAINTAIN STREAM BANK COVER BY USING THE AREA ON THE OPPOSITE SIDE OF THE SEWER TO DEPOSIT EXCAVATED MATERIAL DURING CONSTRUCTION WORK. NO VEGETATION SHALL BE DAMAGED OUTSIDE THE CONSTRUCTION LIMITS. MATERIAL STORAGE FOR LONGER THAN 3 DAYS AND CONTINUOUS EQUIPMENT MOVEMENT WITHIN THE DRIPLINE OF TREES TO BE SAVED WILL NOT BE ALLOWED.

RUNOFF SHALL BE DIVERTED WITH WATER BARS OR SWALES TO A SEDIMENT TRAPPING DEVICE A MINIMUM OF 50 FEET FROM THE STREAM.

STOCKPILE TOP SOIL ON UP-SLOPE SIDE OF THE SEWER TRENCH AND REPLACE DURING FINAL RESTORATION; PROVIDE EROSION CONTROL FOR ALL STOCKPILED AREAS.

TEMPORARILY STABILIZE BY SEEDING PER ITEM 207 ALL LAND DISTURBED IMMEDIATELY FOLLOWING TRENCH BACKFILL UNTIL FINAL RESTORATION IS COMPLETED.

FINAL RESTORATION SHALL BEGIN SOON AS POSSIBLE AFTER CONSTRUCTION IN THE AREA IS COMPLETED. FINAL RESTORATION SHALL BE PHASED TO FOLLOW CLOSELY WITH COMPLETION OF FINAL GRADING WORK.



FINAL GRADING WORK SHALL BE CONSISTENT WITH PRE-CONSTRUCTION TOPOGRAPHY. FINAL GRADING SHALL BE PHASED TO FOLLOW SEWER CONSTRUCTION AND SHALL BE COMPLETED AS SOON AS AREAS ARE NO LONGER NEEDED FOR TRAFFICKING OF CONSTRUCTION EQUIPMENT AND MATERIALS.

NO CHEMICALS, FUELS, LUBRICANTS, BITUMINOUS MATERIAL, RAW SEWAGE, TREES, BRUSH, OR DEBRIS FROM DEMOLITION OR EXCAVATION ACTIVITIES WILL BE DISCHARGED OR DISPOSED OF ONTO OR ALONGSIDE ANY STREAM, WATERCOURSE, FLOODPLAIN, OR WETLAND UNDER ANY CIRCUMSTANCES.


FINAL STREAM BANK STABILIZATION SHALL BE COMPLETED IMMEDIATELY AFTER COMPLETION OF THE STREAM CROSSING. BANK STABILIZATION SHALL INCLUDE SEEDING, ACCORDING TO ITEM 659, AND THE PLACEMENT OF EXCELSIOR MATTING, OR similar EROSION CONTROL MEASURES, ACCORDING TO THE MANUFACTURER'S INSTRUCTIONS. THE STREAM BANK SHALL BE STABILIZED WITHIN 48 HOURS OF THE COMPLETION OF THE STREAM CROSSING.

STREAM CROSSINGS: DISTURBED STREAM BANKS WILL BE STABILIZED AND THE ENTIRE CONSTRUCTION SITE AT THE STREAM CROSSING WILL BE IMMEDIATELY RESTORED UPON COMPLETION OF THE WORK THERE. NATURAL STREAM COURSE WILL NOT BE ALTERED.

STOCKPILED BEDDING AND BACKFILL MATERIAL SHALL NOT BE STORED WITHIN THE RIPARIAN ZONE.

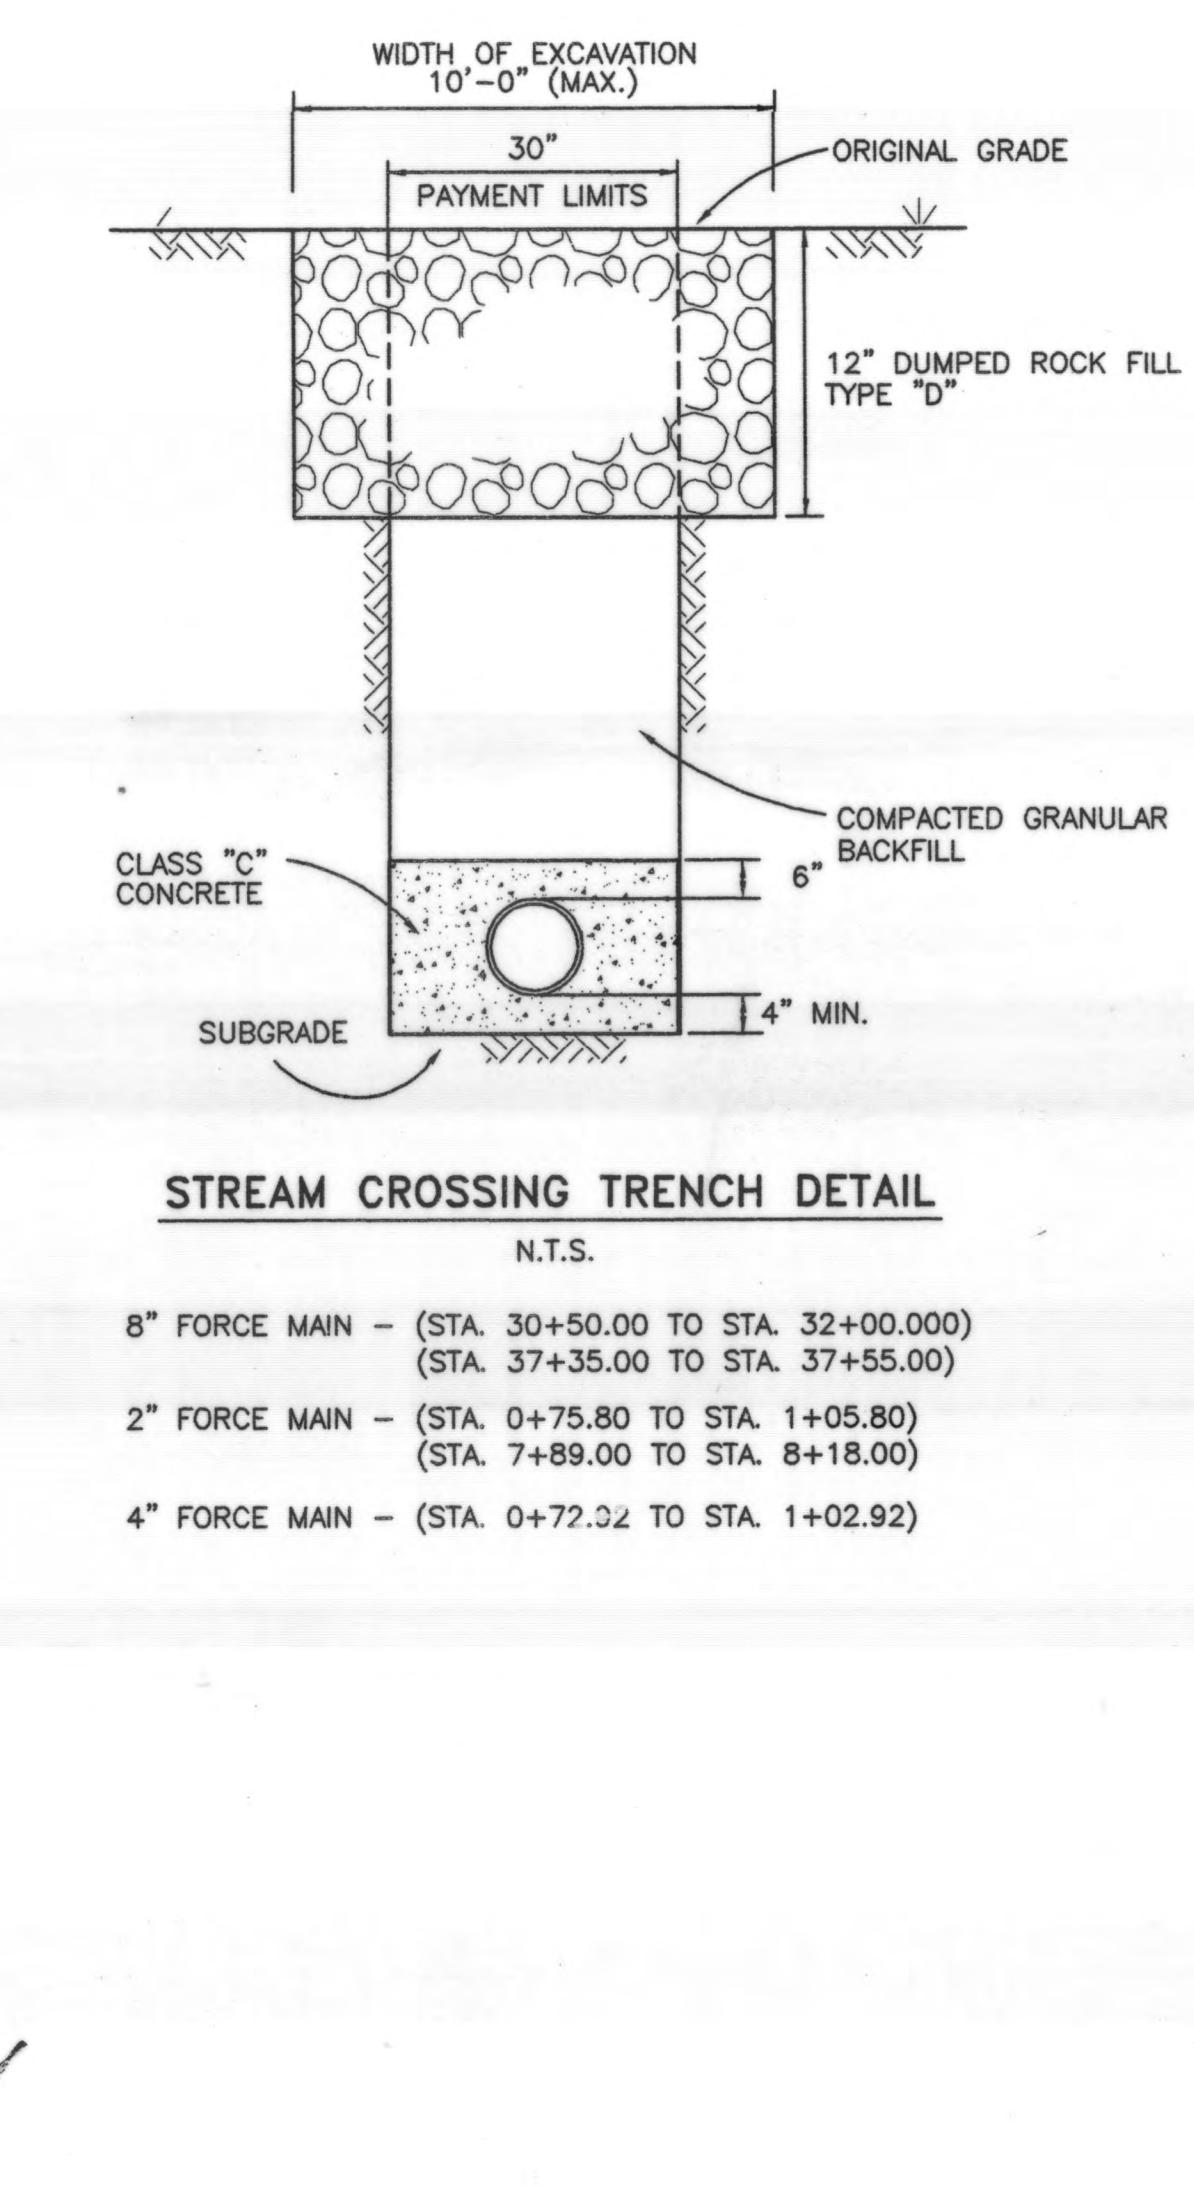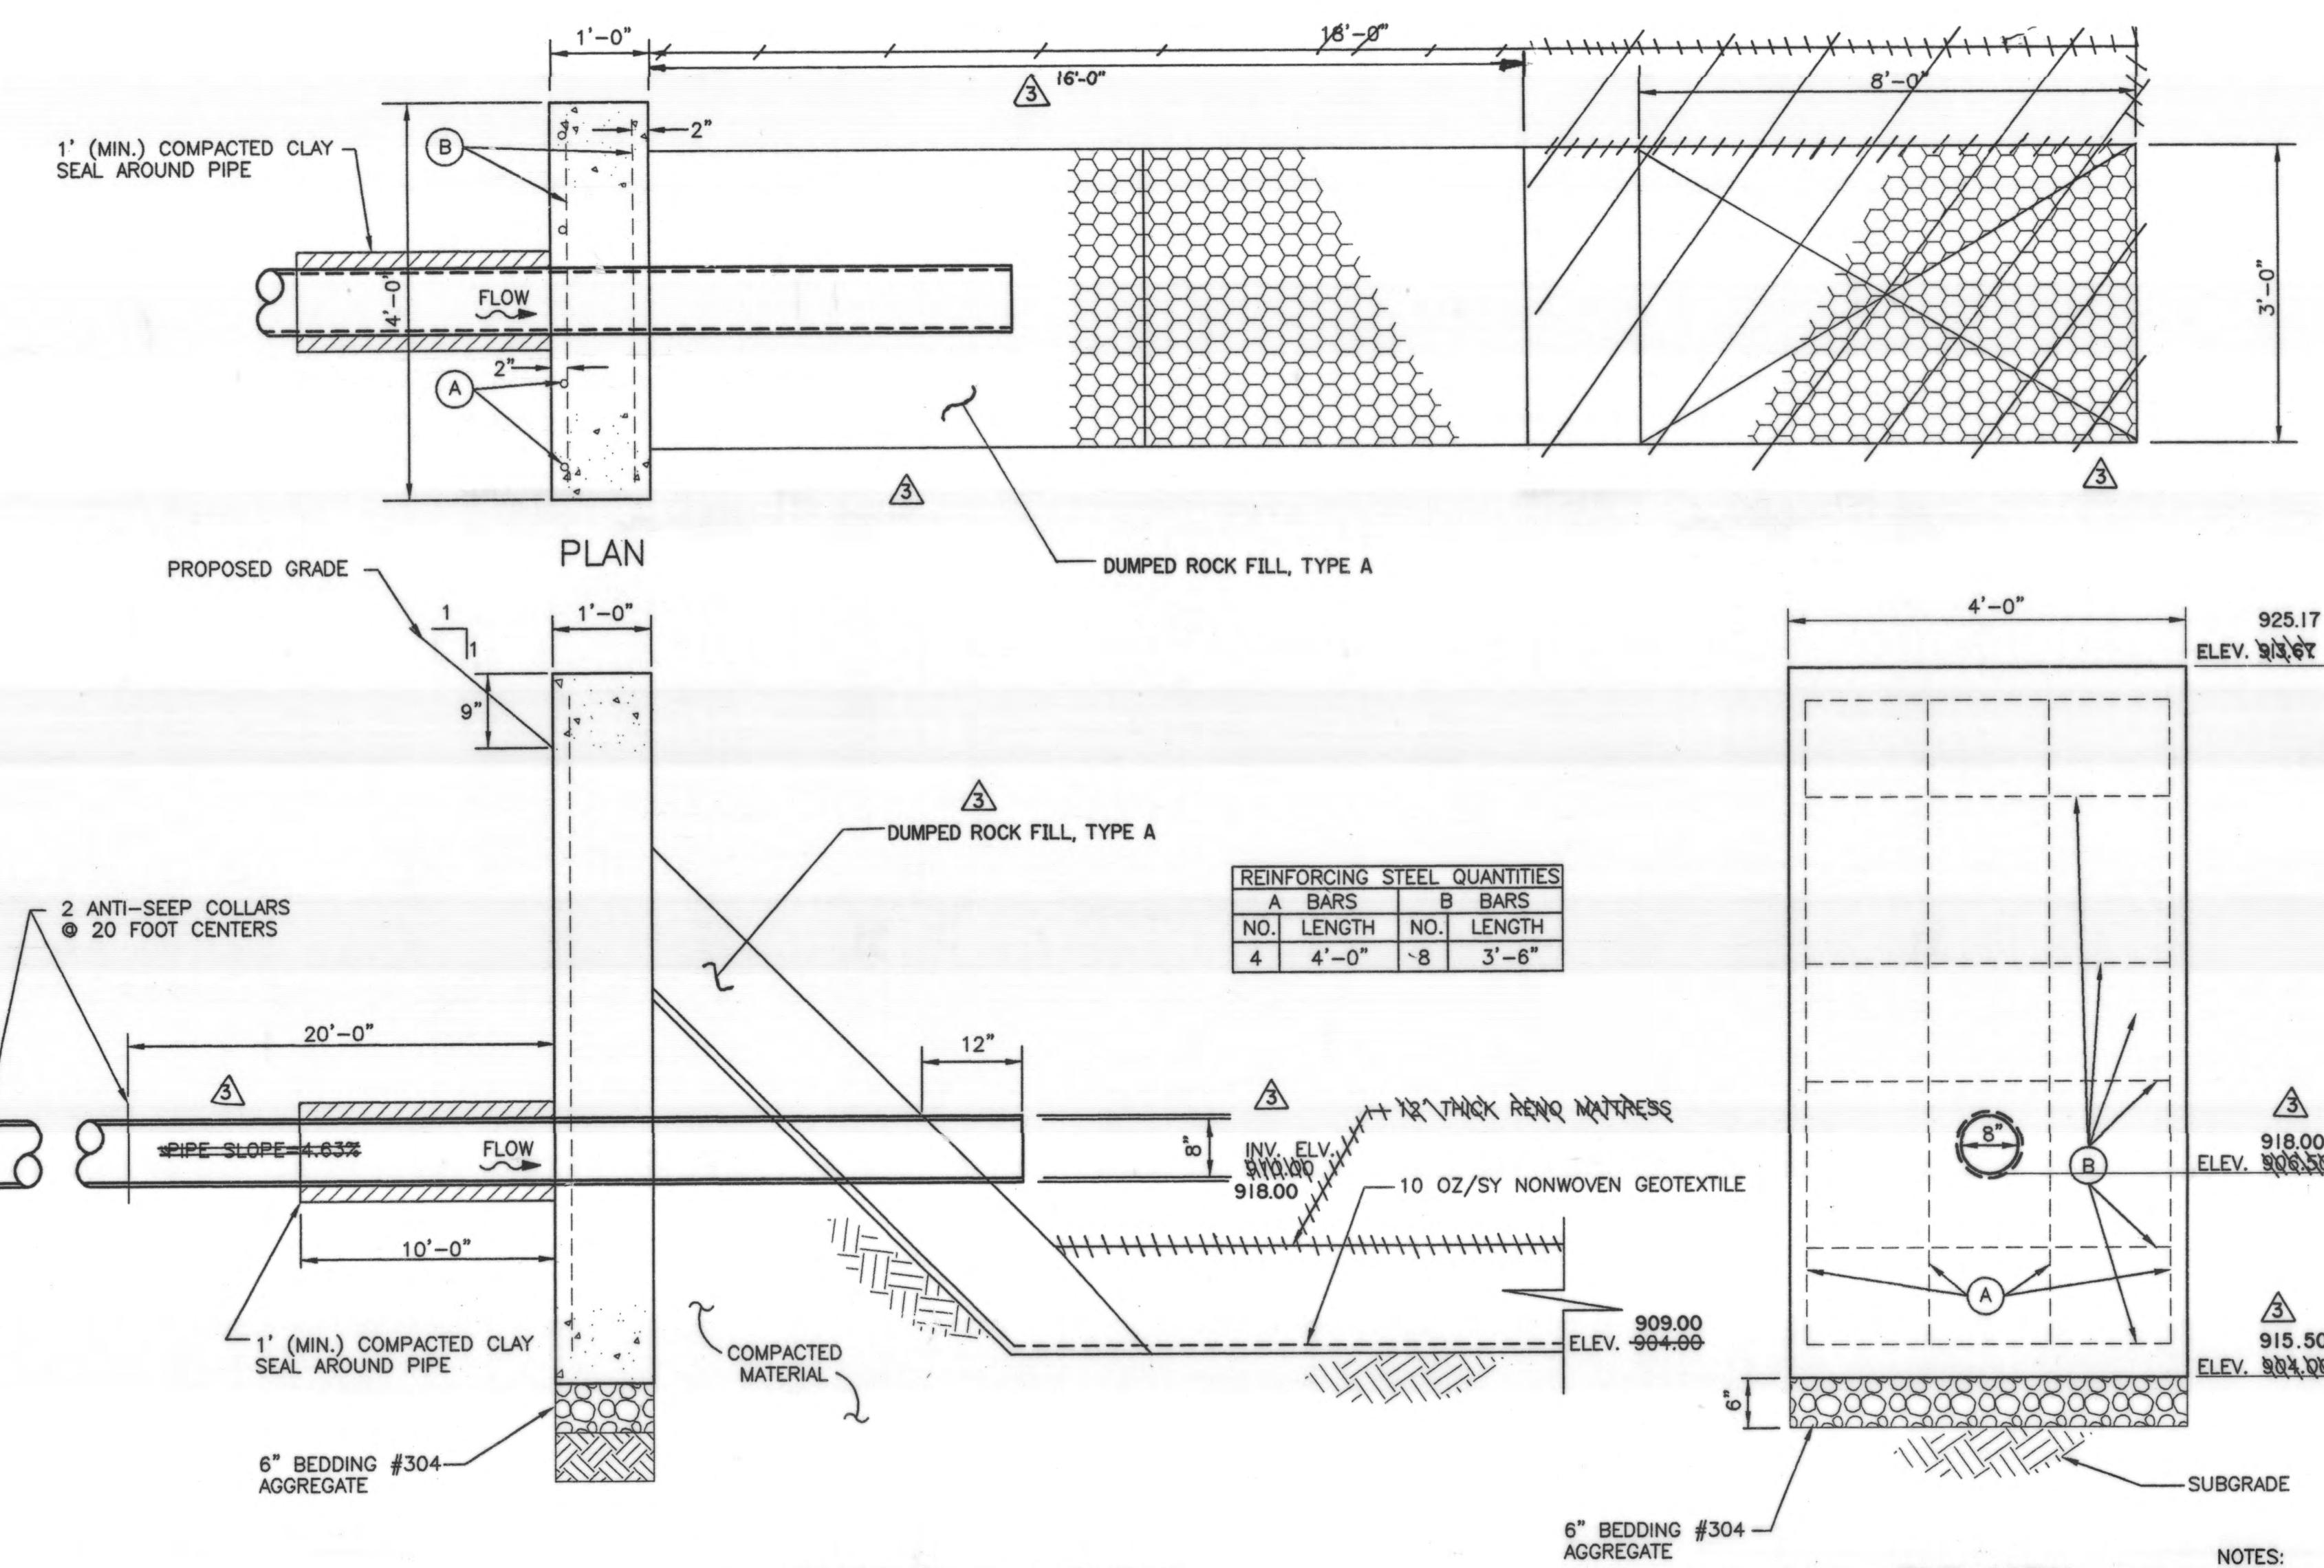

- NOTES:
1. ONE LAYER OF 10 OZ. PER S.Y. WOVEN GEOTEXTILE SHALL BE INSTALLED BEHIND RENO MATTRESS LINING AS SHOWN ON THE PLANS AND IN ACCORDANCE TO THE MANUFACTURER'S REQUIREMENTS. 2. ONE LAYER OF 10 OZ. PER S.Y. WOVEN GEOTEXTILE OVERLAP IS REQUIRED WHEN JOINING TWO SECTIONS OF MATERIAL.
 2. GABIONS SHALL BE A DOUBLE TWISTED HEXAGONAL WOVEN STEEL WIRE MESH OF NOMINAL SIZE TWO AND ONE-HALF INCHES BY THREE AND ONE-QUARTER INCHES. STONE PLACED IN THE WIRE MESH SHALL BE POORLY GRADED WITH A MEAN SPHERICAL DIAMETER (D50) MINIMUM DIAMETER OF FIVE INCHES.
 3. COST TO BE INCLUDED WITH THE COST OF THE CONCRETE HEADWALL.
 4. ANTI-SEEP COLLARS SHALL BE 12-INCHES WIDER THAN THE TRENCH WIDTH. TRENCH SHALL BE BACKFILLED WITH COHESIVE SOIL MATERIALS.

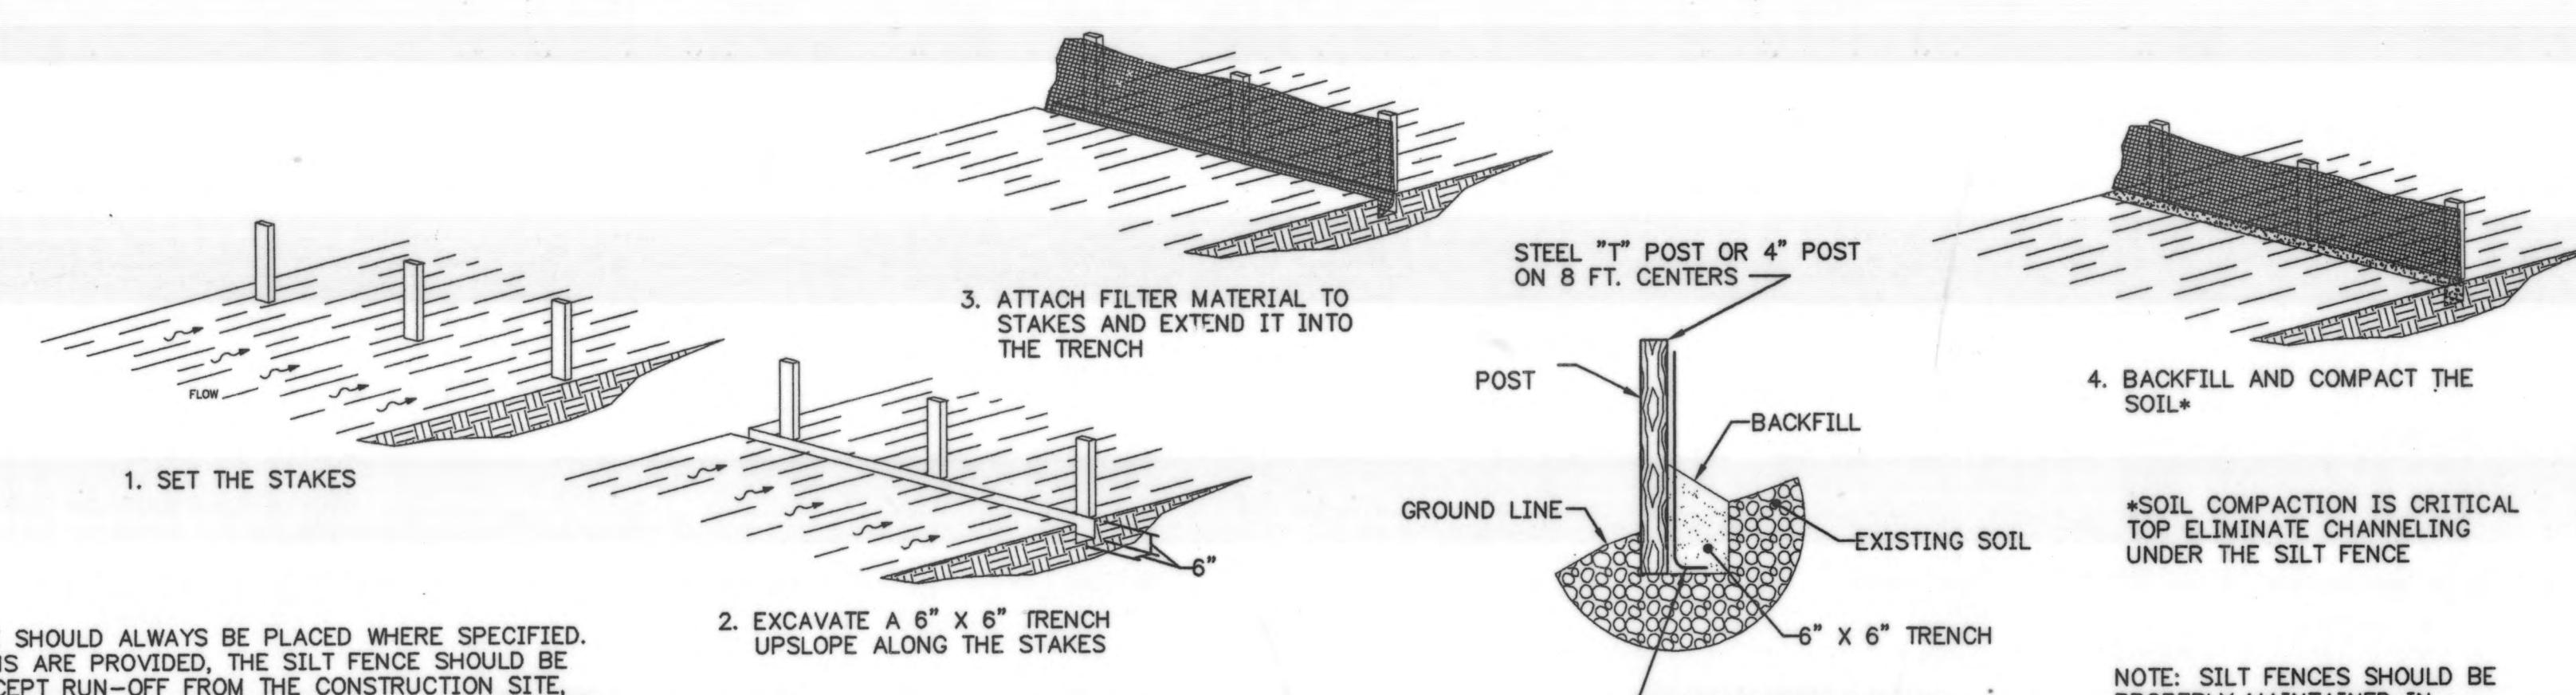


EROSION CONTROL DETAILS

NOTE: SILT FENCES SHOULD BE PROVIDED IN AN EFFECTIVE WORKING CONDITION DURING CONSTRUCTION AND REMAIN IN PLACE UNTIL THE SITE IS PERMANENTLY STABILIZED.

DESIGNED BY:	BGD	REVISIONS
DRAWN BY:	ACM	DATE
CHECKED BY:	THB	9/1/99
APPROVED BY:	MBT	ADDED II. 25° BEND, MOVED MANHOLE, END INVERT, & HEADWALL LOCATION. CHANGED RENO MATTRESS TO DUMPED ROCK FILL.
DATE:	JANUARY 25, 1999	
JOB NO.	4363EN	

DELAWARE COUNTY
DELAWARE COUNTY SANITARY ENGINEER

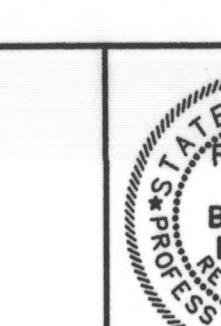

SCIOTO RESERVE
8", 4" & 2" FORCE MAINS

SCALE:	GENERAL	SHEET NO.
NOT TO SCALE	DETAILS	FM-14



DESIGNED BY:	BGD	REVISIONS
DRAWN BY:	ACM	DATE
CHECKED BY:	THB	
APPROVED BY:	MBT	
DATE:	JANUARY 25, 1999	
JOB NO.	4363EN	

REMARKS

DELAWARE COUNTY
DELAWARE COUNTY SANITARY ENGINEER



SCIOTO RESERVE
8", 4" & 2" FORCE MAINS

SCALE:
HORZ. 1"=100'

LIFT STATION
SITE PLAN

SHEET NO.
LS-1

LIFT STATION GENERAL NOTES

THE CONTRACTOR SHALL COMPLY WITH THE MATERIAL AND CONSTRUCTION REQUIREMENTS OF THE DELAWARE COUNTY DOCUMENTED LIFT STATION PLANS AND SPECIFICATIONS FOR CONSTRUCTION OF SANITARY FACILITIES SECTION 7.1. THE CONTRACTOR SHALL OBTAIN ANY AND ALL PERMITS REQUIRED BY THE BOARD OF HEALTH AND PAY ALL PERMIT FEES.

THE CONTRACTOR SHALL FURNISH ALL MATERIALS, LABOR, TOOLS, TRANSPORTATION, ACCIDENTALS AND APPURTENANCES COMPLETE IN EVERY DETAIL, AND LEAVE IN WORKING ORDER, ALL ITEMS OF WORK CALLED FOR AND/OR SHOWN ON THE DRAWINGS. ANY MATERIALS OR WORK NOT SPECIFICALLY MENTIONED OR SHOWN ON THE DRAWINGS, BUT NECESSARY TO COMPLETE THE WORK, SHALL BE FURNISHED.

THE CONTRACTOR IS REQUIRED TO VISIT THE SITE AND FULLY INFORM HIMSELF CONCERNING ALL CONDITIONS AFFECTING THE SCOPE OF THE WORK. FAILURE TO VISIT THE SITE SHALL NOT RELIEVE THE CONTRACTOR FROM ANY RESPONSIBILITY IN THE PERFORMANCE OF THIS CONTRACT.

THE CONTRACTOR SHALL INVESTIGATE AND LOCATE ALL EXISTING UTILITIES AND NOTIFY ALL UTILITY COMPANIES A MINIMUM OF 48 HOURS PRIOR TO BEGINNING ANY CONSTRUCTION ACTIVITIES THAT WILL DISTURB OR ENROACH UPON EXISTING UTILITIES.

THE CONTRACTOR SHALL PROVIDE 4" TO 6" OF SAND OR GRT LEVELING BASE, DEPENDING ON SUBSURFACE SOIL CONDITIONS, UNDER EACH CONCRETE STRUCTURE FOLLOWED BY A MINIMUM OF 6" COMPACTED GRANULAR FILL.

THE CONTRACTOR SHALL GRADE THE AREA AROUND THE LIFT STATION TO DRAIN SURFACE WATER AWAY FROM THE STRUCTURES.

ALL DISTURBED AREAS SHALL BE SEDED AND MULCHED AFTER FINAL GRADING.

ALL GENERAL NOTES SHOWN ON SHEET FM-1, WHERE APPLICABLE AND NOT COVERED IN THE NOTES ON THE LIFT STATION DRAWINGS, SHALL BE CONSIDERED AS A REQUIREMENT FOR THE CONSTRUCTION WORK OF THE LIFT STATION.

ELECTRICAL NOTES

THE CONTRACTOR SHALL PROVIDE ALL ELECTRICAL COMPONENTS AND DEVICES TO PROPERLY SERVE THE ELECTRICAL REQUIREMENTS OF THE LIFT STATION. ALL WORKING MATERIALS AND EQUIPMENT SHALL COMPLY WITH THE OHIO BASIC ELECTRICAL CODE, NATIONAL ELECTRICAL CODE, LOCAL BUILDING CODES AND ALL OTHER REGULATIONS BY AUTHORITIES HAVING JURISDICTIONAL RIGHTS FOR THE ENFORCEMENT OF CONSTRUCTION AND SAFETY STANDARDS. THE CONTRACTOR SHALL PAY THE COSTS OR FEES FOR ANY PERMITS OR AGENCY INSPECTION CHARGES ASSOCIATED WITH THE ELECTRICAL WORK.

ELECTRICAL SERVICE SHALL BE PROVIDED TO WITHIN APPROXIMATELY TEN (10) FEET OF THE PROPOSED LIFT STATION, TERMINATING AT THE CONTRACTOR'S PROPERTY LINE. ELECTRICAL CONNECTIONS WILL BE PERFORMED BY THE LIFT STATION CONTRACTOR. THE COST FOR PURCHASING AND INSTALLING THE ELECTRIC METER SHALL BE AT THE CONTRACTOR'S EXPENSE. THE CONTRACTOR SHALL MAKE ALL ARRANGEMENTS AND PAY ALL FEES REQUIRED FOR MAKING THE PROPER CONNECTIONS TO THE COLUMBUS SOUTHERN POWER SERVICE WIRING.

A FEMALE RECEPTACLE FOR CONNECTION TO DELAWARE COUNTY'S PORTABLE EMERGENCY GENERATOR SHALL BE PROVIDED ON THE ELECTRICAL SERVICE PANEL. THE ELECTRICAL SERVICE RATING OF THE RECEPTACLE SHALL BE 100A, 120VAC, MANUFACTURER SHALL BE CRUSOE-HINDS, CATALOGUE NO. AR1041-M72. NO SUBSTITUTIONS SHALL BE PERMITTED.

A MANUAL TRANSFER SWITCH SHALL BE PROVIDED TO TRANSFER LOADS FROM THE LINE SOURCE TO A PORTABLE EMERGENCY GENERATOR. THE SWITCH SHALL BE NON-FUSIBLE, 4 POLE, DOUBLE THROW, IN A NEMA 3R ENCLOSURE MOUNTED ON THE INSIDE OF THE STATION ENCLOSURE. MANUFACTURER SHALL BE SQUARE D CLASS 3140 OR APPROVED EQUAL.

PROVIDE AND INSTALL A LIGHTNING ARRESTOR PER DELAWARE COUNTY STANDARDS.

THE CONTRACTOR SHALL FURNISH AND INSTALL A TELEMETRY SYSTEM AS FOLLOWS:

1. ONE (1) WESTERMAN CT-400 MICROPROCESSOR BOARD, OR APPROVED EQUAL.
2. THREE (3) WESTERMAN I/O-4480 INPUT/OUTPUT BOARD, OR APPROVED EQUAL.
3. ONE (1) WESTERMAN I/O-4240 ANALOG INPUT BOARD, OR APPROVED EQUAL.
4. ONE (1) METRICOM SPREAD SPECTRUM DATA RADIO, MODEL 20043, OR APPROVED EQUAL.
5. ONE (1) WESTERMAN CA-1511 9600 BAUD MODEM, OR APPROVED EQUAL.
6. ONE (1) OMNI-DIRECTIONAL ANTENNA WITH WOODEN MOUNTING POLE IF REQUIRED.
7. ALL RELAYS SHALL BE CRYDOM STYLE, SOLID STATE RELAYS.
8. ONE (1) POWER SONIC 10 AH BATTERY BACK-UP.

ALL TELEMETRY COMPONENTS SHALL BE MOUNTED IN A NEMA 4X, 316 STAINLESS STEEL ENCLOSURE WITH A FABRICATED BACK PANEL AND STRIP HEATER. THE TELEMETRY PANEL SHALL BE INSTALLED IN THE LIFT STATION ENCLOSURE AND MOUNTED NEAR THE PUMP CONTROL PANEL.

ALL PUMP MOTOR STARTERS SHALL BE SOLID STATE TYPE, SERIES SMC BY ALLEN-BRADLEY, OR APPROVED EQUAL.

LIFT STATION SPECIFICATIONS

GENERAL

THE SCOPE OF WORK UNDER THIS CONTRACT INCLUDES FURNISHING AND INSTALLING THE LIFT STATION COMPLETE AS SHOWN ON THE DRAWINGS AND AS SPECIFIED HEREIN.

WET WELL AND VALVE VAULT

THE WET WELL AND VALVE VAULT SHALL BE CONSTRUCTED OF PRE-CAST CONCRETE SECTIONS MEETING THE REQUIREMENTS OF ASTM C478.

ALL RISER SECTION JOINTS SHALL BE SEALED WITH ALL RUBBER O-RING SEALS COMPLYING WITH ASTM C443.

ACCESS HATCH AND FRAME ASSEMBLY

A DOUBLE LEAF ALUMINUM ACCESS HATCH SHALL BE CAST INTO THE TOP SLAB OF THE WET WELL SIZE SHALL BE AS SHOWN ON THE DRAWINGS. EACH LEAF OF THE HATCH SHALL BE PROVIDED WITH AN AUTOMATIC HOLD OPEN ARM AND COVER RELEASE. EACH LEAF SHALL HAVE A SLAM LOCKING MECHANISM WITH A REMOVABLE KEY WRENCH OPERATING HANDLE. A HASP SHALL BE PROVIDED FOR PADLOCKING BOTH LEAVES OF THE COVER.

THE ACCESS HATCH FRAME SHALL HAVE A DRAINAGE CHANNEL WITH AN INTEGRAL PIPE NIPPLE IN ONE CORNER OF THE FRAME FOR CONNECTING A TWO (2) INCH DRAIN LINE.

MANUFACTURER SHALL BE BILCO, "JD" SERIES, OR APPROVED EQUAL BY HALLIDAY PRODUCTS.

PIPING

THE CONTRACTOR SHALL FURNISH AND INSTALL ALL PIPING FITTINGS AND VALVES IN THE WET WELL AND VALVE VAULT AS SHOWN ON THE DRAWINGS. PIPE, FITTINGS AND VALVES SHALL BE FLANGED DUCTILE IRON CLASS 52 MINIMUM, AS MANUFACTURED BY CLOW OR MUELLER, AND CONFORMING TO AWWA C110, C150 AND C151. GASKETS SHALL BE FULL FACED RUBBER MEETING THE REQUIREMENTS OF AWWA C111.

PUMPS

FURNISH AND INSTALL TWO (2) SUBMERSIBLE PUMPS WITH DUPLEX CONTROLS AS MANUFACTURED BY FLYGT CORPORATION OR EQUAL BY GORMAN-RUPP COMPANY.

MOTORS AND RELATED ELECTRICAL EQUIPMENT SHALL BE EXPLOSION PROOF MEETING THE REQUIREMENTS OF THE NATIONAL ELECTRIC CODE FOR CLASS 1, DIVISION 1, GROUP D ENVIRONMENTS.

PUMP IMPELLERS SHALL BE NON-CLOG TYPE CAPABLE OF PASSING A 3-INCH SPHERE.

THE PUMP SHALL HAVE A CAPACITY OF 220 GPM AT A TOTAL DYNAMIC HEAD OF 50 FEET. MOTOR SHALL BE 10HP, 1750 RPM DESIGNED FOR OPERATION AT 460V, 3 PHASE, 60 Hz POWER. PUMP TURN OFF HEAD SHALL BE 70 FEET (MIN). MOTOR SHALL BE NON-OVERLOADING OVER FULL RANGE OF PUMP CURVE. PUMP EFFICIENCY AT DESIGN FLOW SHALL EXCEED 60%.

THE PUMP VOLUTE CASING, IMPELLER AND MOTOR HOUSING SHALL BE CONSTRUCTED OF CAST IRON ON NO LESSER GRADE THAN CLASS C PER ASTM A48. THE MOTOR SHAFT SHALL BE 316 STAINLESS STEEL WITH DOUBLE MECHANICAL SEAL ASSEMBLY AND LEAK SENSOR.

PUMP INSTALLATION

THE INSTALLATION AND REMOVAL SYSTEM FOR EACH PUMP SHALL CONSIST OF A STATIONARY CAST IRON DISCHARGE ELBOW WITH 125 LB FLANGES AND TWO GUIDE RAILS. GUIDE RAILS SHALL BE 316 STAINLESS STEEL AND THE PUMP SHALL BE ATTACHED TO A SUPPORT BASE THAT IS ANCHORED TO THE FLANGE OF THE WET WELL. THE GUIDE RAILS SHALL BE SECURED AT THE TOP WITH A CAP THAT IS ATTACHED TO THE FRAME OF THE ACCESS HATCH.

A SLIDING BRACKET ASSEMBLY WITH A YOKE CONNECTION TO THE GUIDE RAILS SHALL BE ATTACHED TO EACH PUMP VOLUTE. THE YOKE SHALL BE CONSTRUCTED OF U.L. LISTED, NON-SPARKING BRONZE DESIGNED FOR EXPLOSION PROOF SERVICE.

THE DESIGN OF THE SLIDING BRACKET ASSEMBLY SHALL BE SUCH THAT A MINIMUM FORCE IS EXERTED BETWEEN THE BASE ELBOW AND PUMP DISCHARGE WHILE PROVIDING A POSITIVE SEAL WITHOUT BOLTING OR FASTENING AND TO PROVIDE FOR EASY BREAK AWAY WHEN LIFTING THE PUMP.

PORTABLE HOIST

THE CONTRACTOR SHALL PROVIDE ONE (1) PORTABLE DAVIT TYPE HOIST WITH A HAND WINCH WITH ADEQUATE CAPACITY TO SET IN PLACE OR REMOVE THE SPECIFIED PUMPS. LIFTING CAPACITY OF THE HOIST SHALL BE A MINIMUM OF 50% GREATER THAN THE WEIGHT OF A PUMP INCLUDING MOTOR AND SLIDING BRACKET ASSEMBLY.

THE WINCH ASSEMBLY, HOOK, CABLE, DAVIT, DAVIT ADJUSTMENT CHAIN, AND MAST SHALL BE CONSTRUCTED OF 316 STAINLESS STEEL.

A MOUNTING SOCKET SHALL BE PROVIDED FOR SETTING THE MAST OF THE HOIST. THE SOCKET SHALL BE IMBEDDED IN THE TOP SLAB OF THE WET WELL AND LOCATED AS SHOWN ON THE DRAWINGS.

MANUFACTURER AND MODEL SHALL BE HALLIDAY PRODUCTS, SERIES "DB", OR APPROVED EQUAL.

PUMP CONTROLS

PUMPS SHALL BE CONTROLLED BY MEANS OF AN ULTRASONIC LEVEL SENSOR AND TRANSDUCER.

A DUPLEX PUMP CONTROLLER IN A REMOVABLE NEMA 12 STAINLESS STEEL PANEL SHALL BE MOUNTED WITHIN THE LIFT STATION ENCLOSURE. IT SHALL CONTAIN A CIRCUIT BREAKER, MAGNETIC STARTERS, HAND-OFF-AUTO SELECTOR SWITCH, ELAPSED TIME METER, AND SEAL LEAK INDICATING LIGHT FOR PUMP. THE CONTROL PANEL SHALL CONTAIN AN ALTERNATOR RELAY TO ALTERNATE PUMPS ON EACH SUCCESSIVE PUMP CYCLE AND SHALL TURN ON THE SECOND (LAG) PUMP IF THE FIRST (LEAD) PUMP FAILS OR THE INFLOW EXCEEDS THE CAPACITY OF ONE PUMP.

THE PUMPS POWER CABLE SHALL BE SUPPORTED FROM THE WET WELL BY BASIC WEAVE STAINLESS STEEL CABLE SUPPORT GRIPS (KELLIUM GRIPS).

A 120VAC DUPLEX CONVENIENCE OUTLET WITH GROUND FAULT INTERRUPT PROTECTION SHALL BE PROVIDED.

LEVEL SENSOR CABLE SHALL BE INSTALLED IN A 1" PVC CONDUIT FROM THE LEVEL SENSOR HEAD TO THE PUMP CONTROL PANEL IN THE LIFT STATION ENCLOSURE. PROVIDE SEAL FITTINGS WHERE CONDUIT ENTERS THE CONTROL PANEL.

EACH PUMP POWER CABLE SHALL BE INSTALLED IN A 2" PVC CONDUIT FROM THE WET WELL TO THE PUMP CONTROL PANEL. PROVIDE SEAL FITTINGS WHERE CONDUIT ENTERS THE CONTROL PANEL.

ODOR CONTROL

A "BIODIE" ODOR CONTROL SYSTEM AS MANUFACTURED BY U.S. FILTER/DAKOTA PROCESS SHALL BE FURNISHED AND INSTALLED BY THE CONTRACTOR, AS SHOWN ON THE DRAWINGS. THIS SYSTEM SHALL INCLUDE THE FOLLOWING COMPONENTS AS A MINIMUM:

1. ONE (1) 1,450 GALLON HIGH DENSITY CROSS LINKED POLYETHYLENE 150°F CHEMICAL STORAGE TANK (7'-1" DIAM X 8' HIGH).

2. ONE (1) COMPLETE CONTROL UNIT TO INDEPENDENTLY CONTROL TWO (2) PUMPS. THE PUMP CONTROL UNIT SHALL BE HOUSED IN A HEATED 316 STAINLESS STEEL NEMA 4X ENCLOSURE MOUNTED ON A 316 SS SUPPORT PEDESTAL. THE CONTROL UNIT/ENCLOSURE SHALL CONSIST OF THE FOLLOWING:

151VAC, 15 AMP CIRCUIT BREAKER
THERMOSTATICO CONTROL HEATER
GFI CONVENIENCE RECEPTACLE
ON/OFF SWITCHES WITH LED INDICATOR LIGHTS
120VAC 15 AMP CIRCUIT BREAKER WITH FLOW CONTROL VALVES
AT TOP AND BOTTOM OF THE CYLINDER.

3. TWO (2) M-15907-001 U.S. FILTER BELLows PUMP WITH AN ADJUSTABLE FEED RATE FROM 5 TO 50 m3/min AT A MAXIMUM DISCHARGE PRESSURE OF 40 PSI.

4. ONE (1) COMPLETE, HEAT TRACED AND INSULATED PIPING KIT CONSISTING OF THE FOLLOWING:

40 FEET OF 1/2 INCH SCHEDULE 40 PVC PIPE
2-INCH STAINLESS STEEL MALE CAMLOCK COUPLING
2-INCH SCHEDULE 80 PVC TANK FILL PIPING
30 FEET OF HEAT TRACING AND INSULATION
HEAT TRACING CONTROLLER

THE CHEMICAL STORAGE TANK SHALL BE MOUNTED ON A CURBED CONCRETE PAD ENCLOSED BY AN 8-FOOT HIGH CEDAR FENCE WITH A PADLOCKED GATE.

PORTABLE PUMPING SYSTEM

PROVIDE ONE (1) PORTABLE PUMPING SYSTEM FOR EMERGENCY PUMP OUT OF THE WET WELL. THE PUMPING SYSTEM SHALL INCLUDE THE FOLLOWING:

1. ENGINE-DRIVEN, SELF-PRIMING, SUCTION-LIFT, CENTRIFUGAL PUMP WITH 6-INCH SUCTION AND DISCHARGE. PUMP SHALL BE DESIGNED TO HANDLE RAW SEWAGE WITH SOLIDS UP TO 3 INCHES IN DIAMETER.

PUMP CASING SHALL BE ALL CAST IRON CONSTRUCTION. IMPELLER SHALL BE CAST CHROMIUM STEEL.

THE PUMP SUCTION HEAD SHALL BE EQUIPPED WITH A BALL TYPE NON-RETURN VALVE WITH A RENEWABLE, FLEXIBLE RUBBER SEAT AND QUICK RELEASE ACCESS FEATURE.


THE SHAFT SEAL SHALL BE A DOUBLE MECHANICAL SEAL RUNNING IN AN OIL BATH. SEALING FACES SHALL BE ABRASION RESISTANT SOLID SILICON CARBIDE.

THE PUMP SHALL HAVE AN AUTOMATIC ON/OFF FEATURE AND SHALL BE DESIGNED FOR A TOTAL SUCTION LIFT OF 30 FEET AND A DISCHARGE CAPACITY OF 500 GPM AT 50 FEET TOH. PUMP MODEL SHALL BE CD150N AS MANUFACTURED BY GODWIN PUMPS, OR APPROVED EQUAL.

2. THE PUMP SHALL BE DRIVEN BY DIESEL ENGINE EQUIPPED WITH AN EXHAUST SILENCER AND A FUEL TANK WITH A MINIMUM CAPACITY OF 60 GALLONS. THE ENGINE AND PUMP SHALL BE TOTALLY ENCLOSED IN 14 GAUGE SHEET METAL PANEL BACKED WITH ACOUSTIC SOUND DEADENING MATERIAL. THE ACOUSTICAL ENCLOSURE SHALL ALLOW A MAXIMUM NOISE LEVEL OF 73dB(A) AT A DISTANCE OF 10 FEET. THE ACOUSTICAL PANELS SHALL BE REMOVABLE FOR ACCESS TO THE PUMP AND ENGINE. THE ENGINE SHALL BE JOHN DEERE 4045D, OR APPROVED EQUAL.


3. THE PUMP AND DIESEL ENGINE SHALL BE TRAILER MOUNTED. THE TRAILER SHALL BE JOHN DEERE GP 60 HIGHWAY TRAILER, OR APPROVED EQUAL.

4. PROVIDE A MINIMUM OF 25 FEET EACH OF 6 INCH SUCTION AND DISCHARGE HOSE. HOSE SHALL BE EQUIPPED WITH INTERCHANGEABLE MALE/FEMALE QUICK CONNECT COUPLINGS, COORDINATE COUPLING TYPE, WITH COUPLINGS ON THE EMERGENCY PUMP OUT CONNECTIONS FOR THE LIFT STATION.

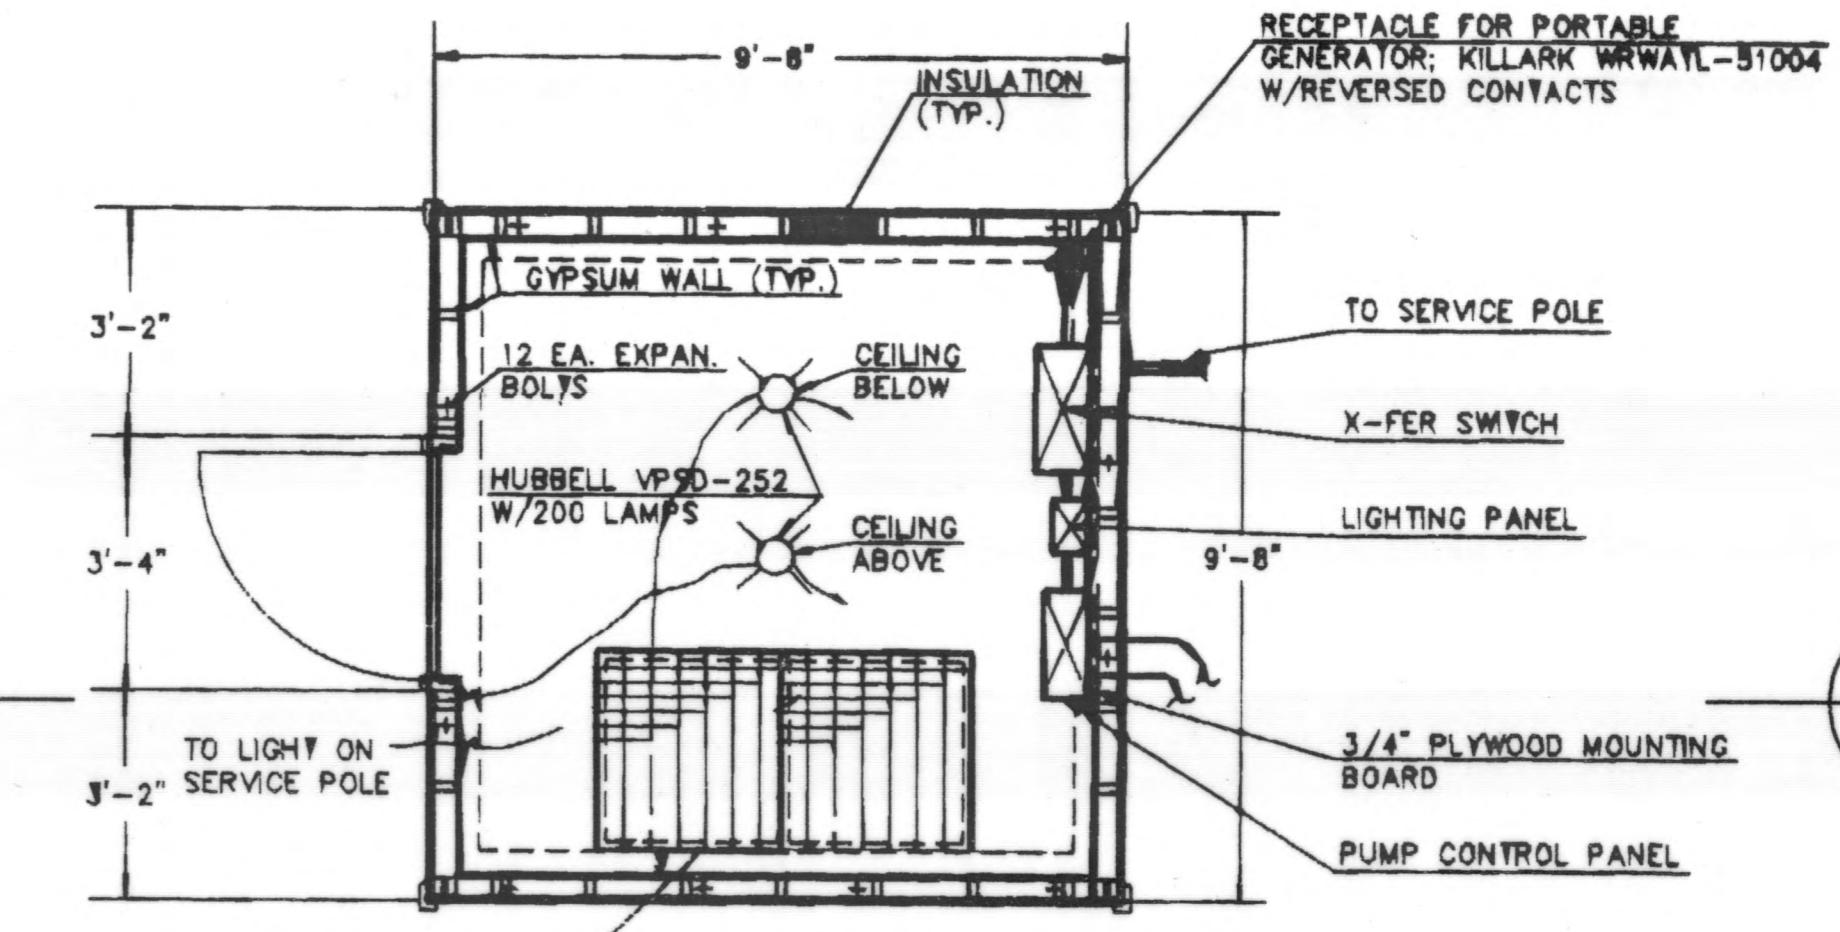


PLAN

SCALE: 3/8" = 1'-0"

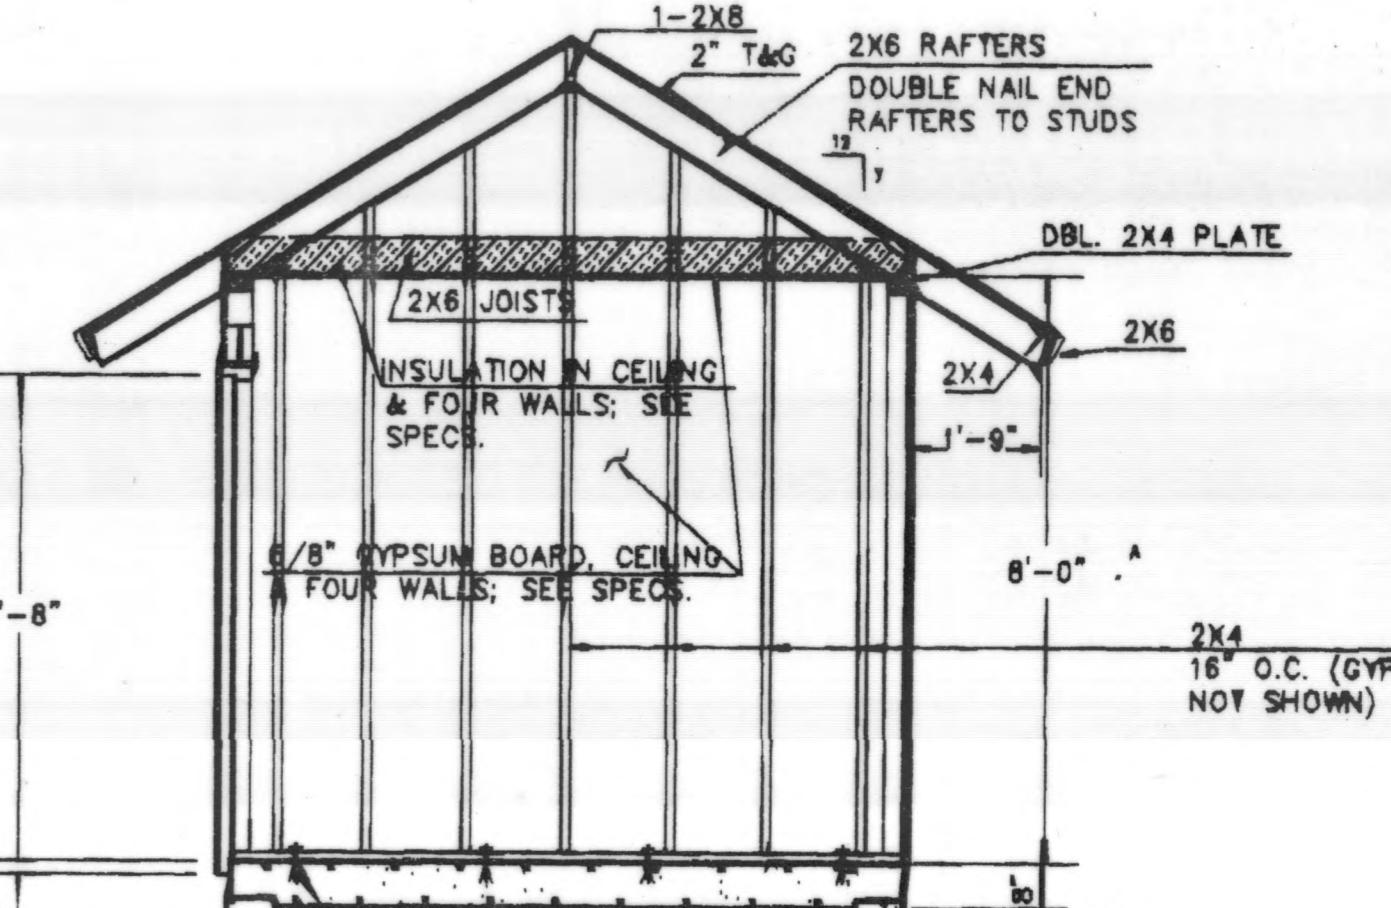



SECTION A-A

SCALE: 3/8" = 1'-0"

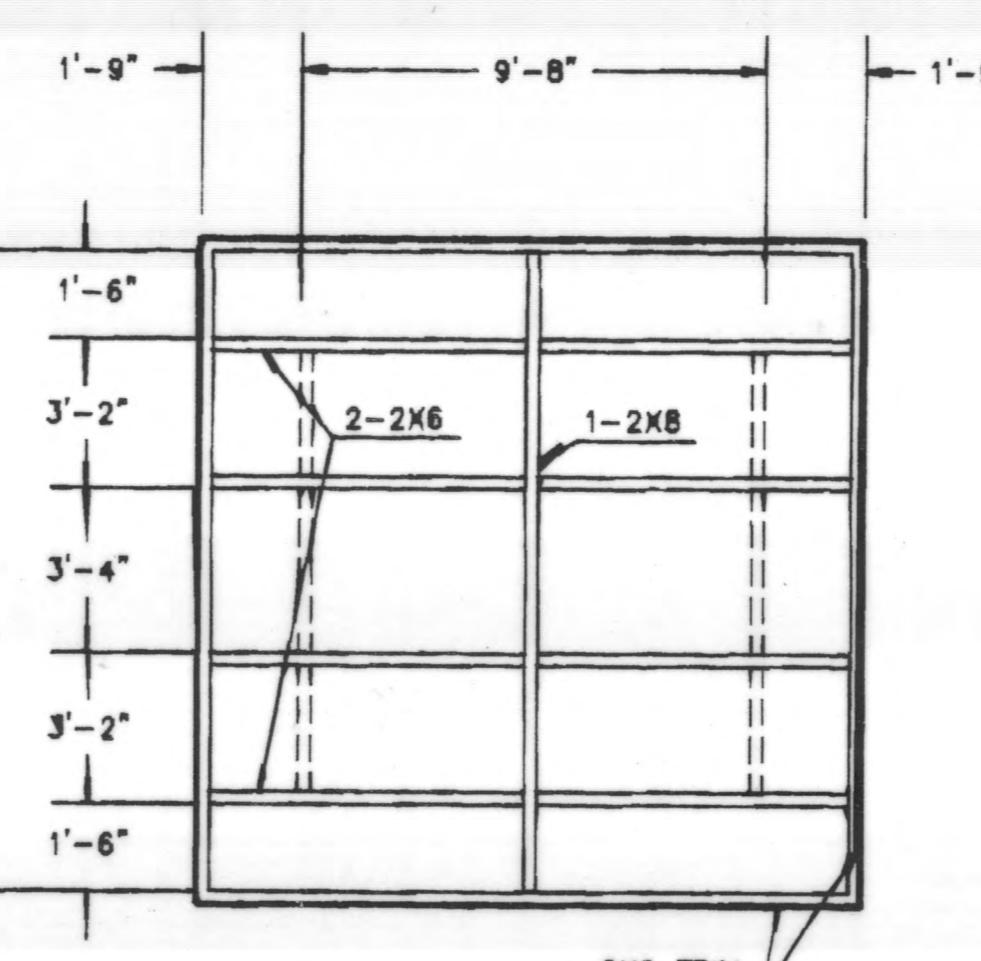


ROOF FRAMING PLAN

SCALE: 1/4" = 1'-0"

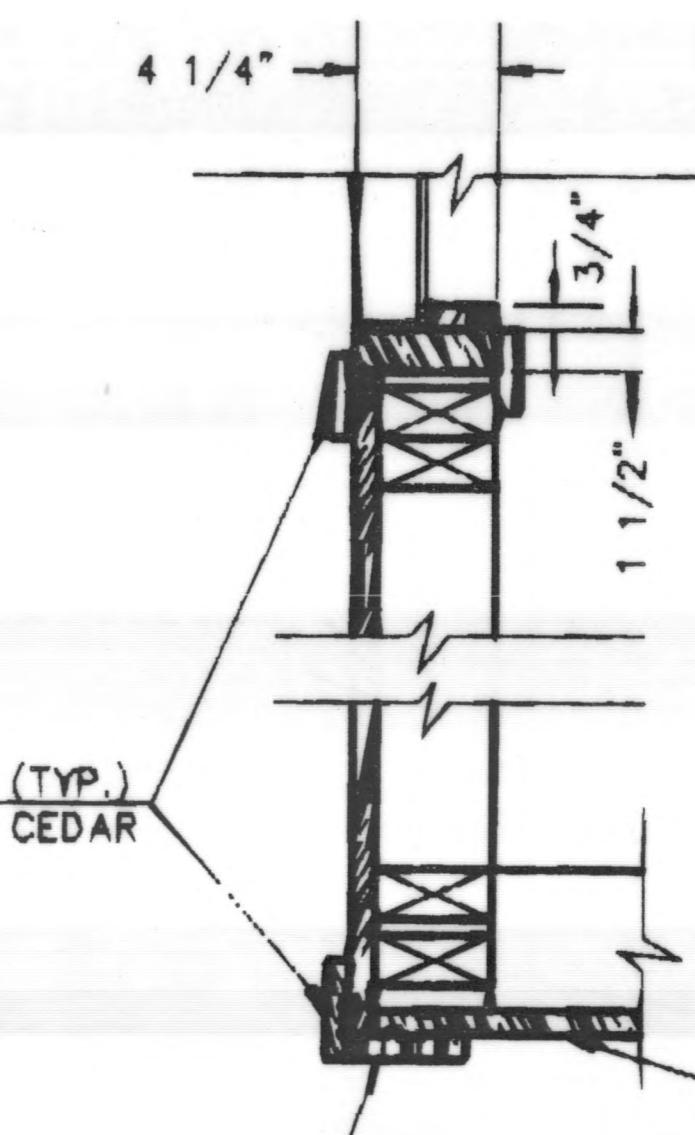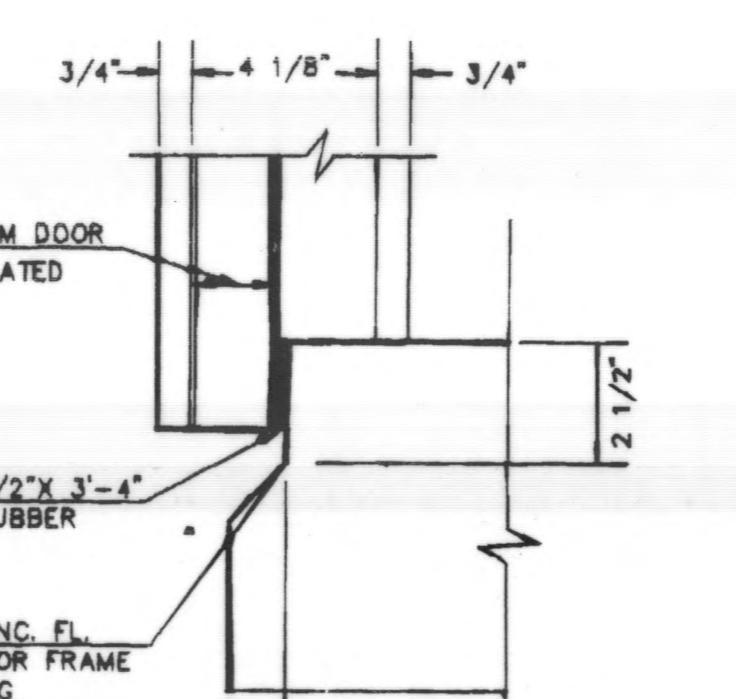


TYPICAL CORNER

SCALE: 1 1/2" = 1'-0"

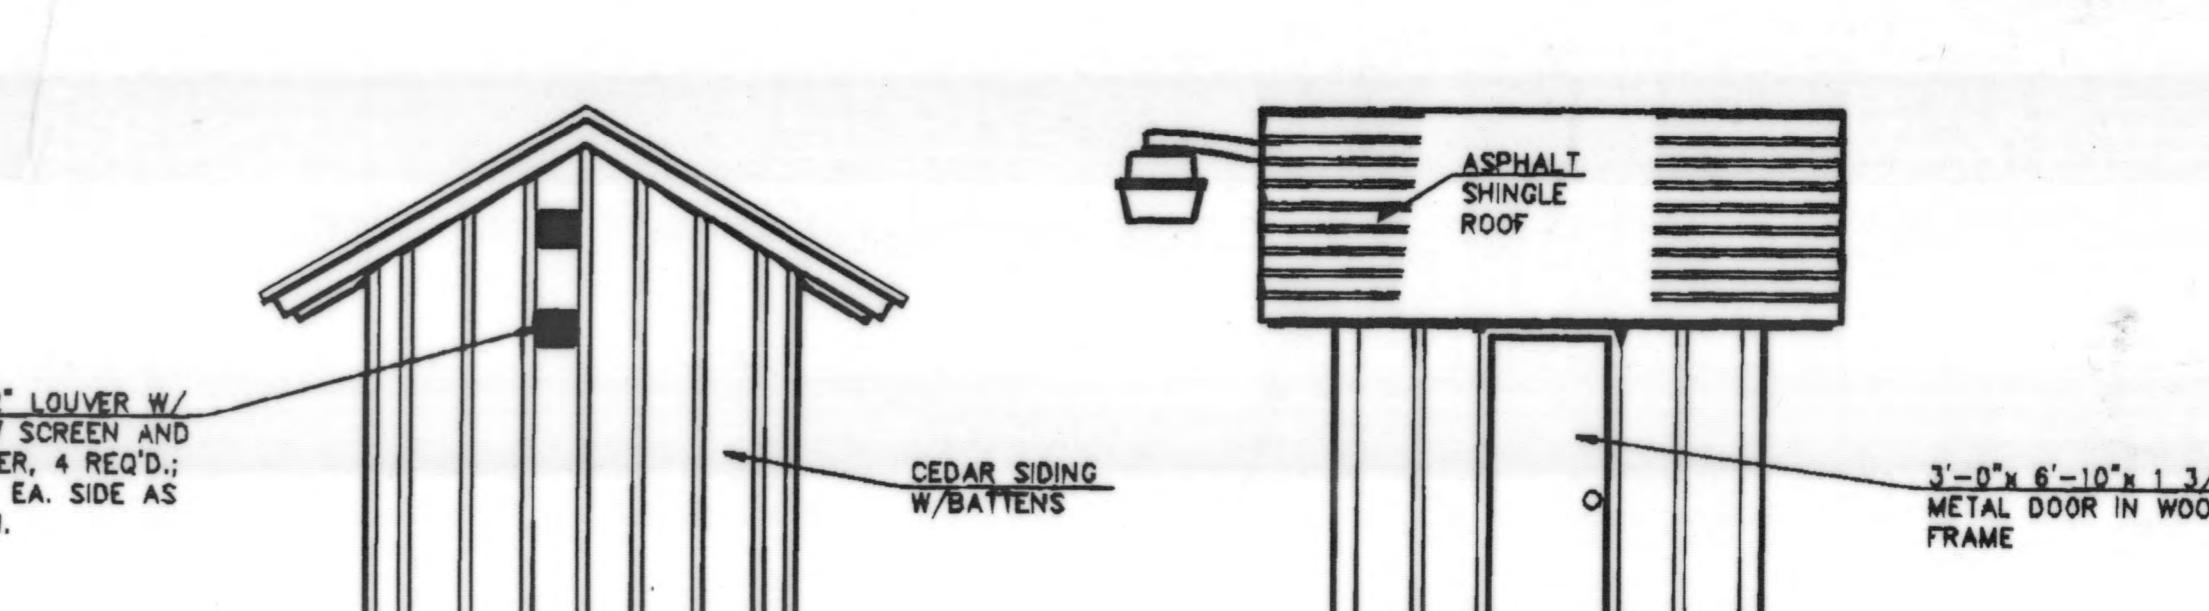

ELEVATIONS

SCALE: 1/4" = 1'-0"

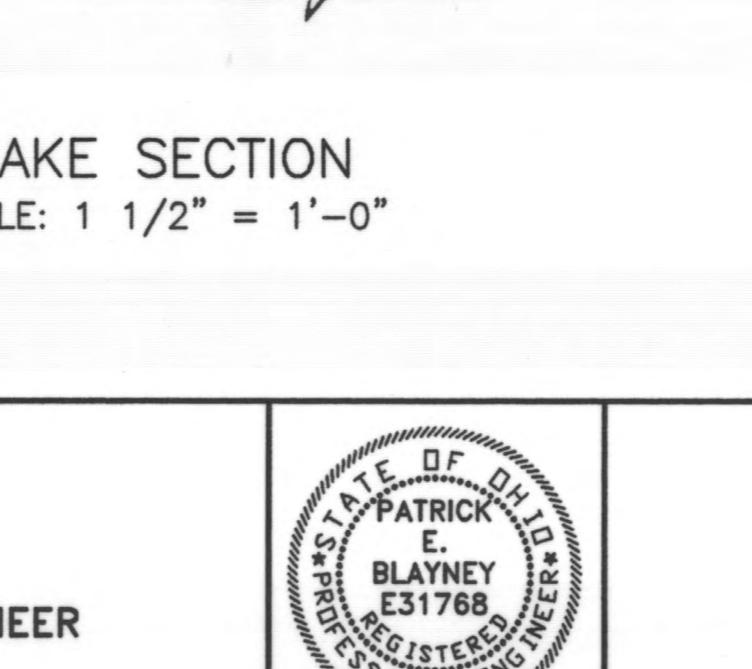

RAKE SECTION


SCALE: 1 1/2" = 1'-0"

SCIOTO RESERVE
LIFT STATION

NOTES AND LIFT STATION
ENCLOSURE

SHEET NO.
LS-2


DESIGNED BY:	THB	REVISIONS
DRAWN BY:	MDK	DATE
CHECK		

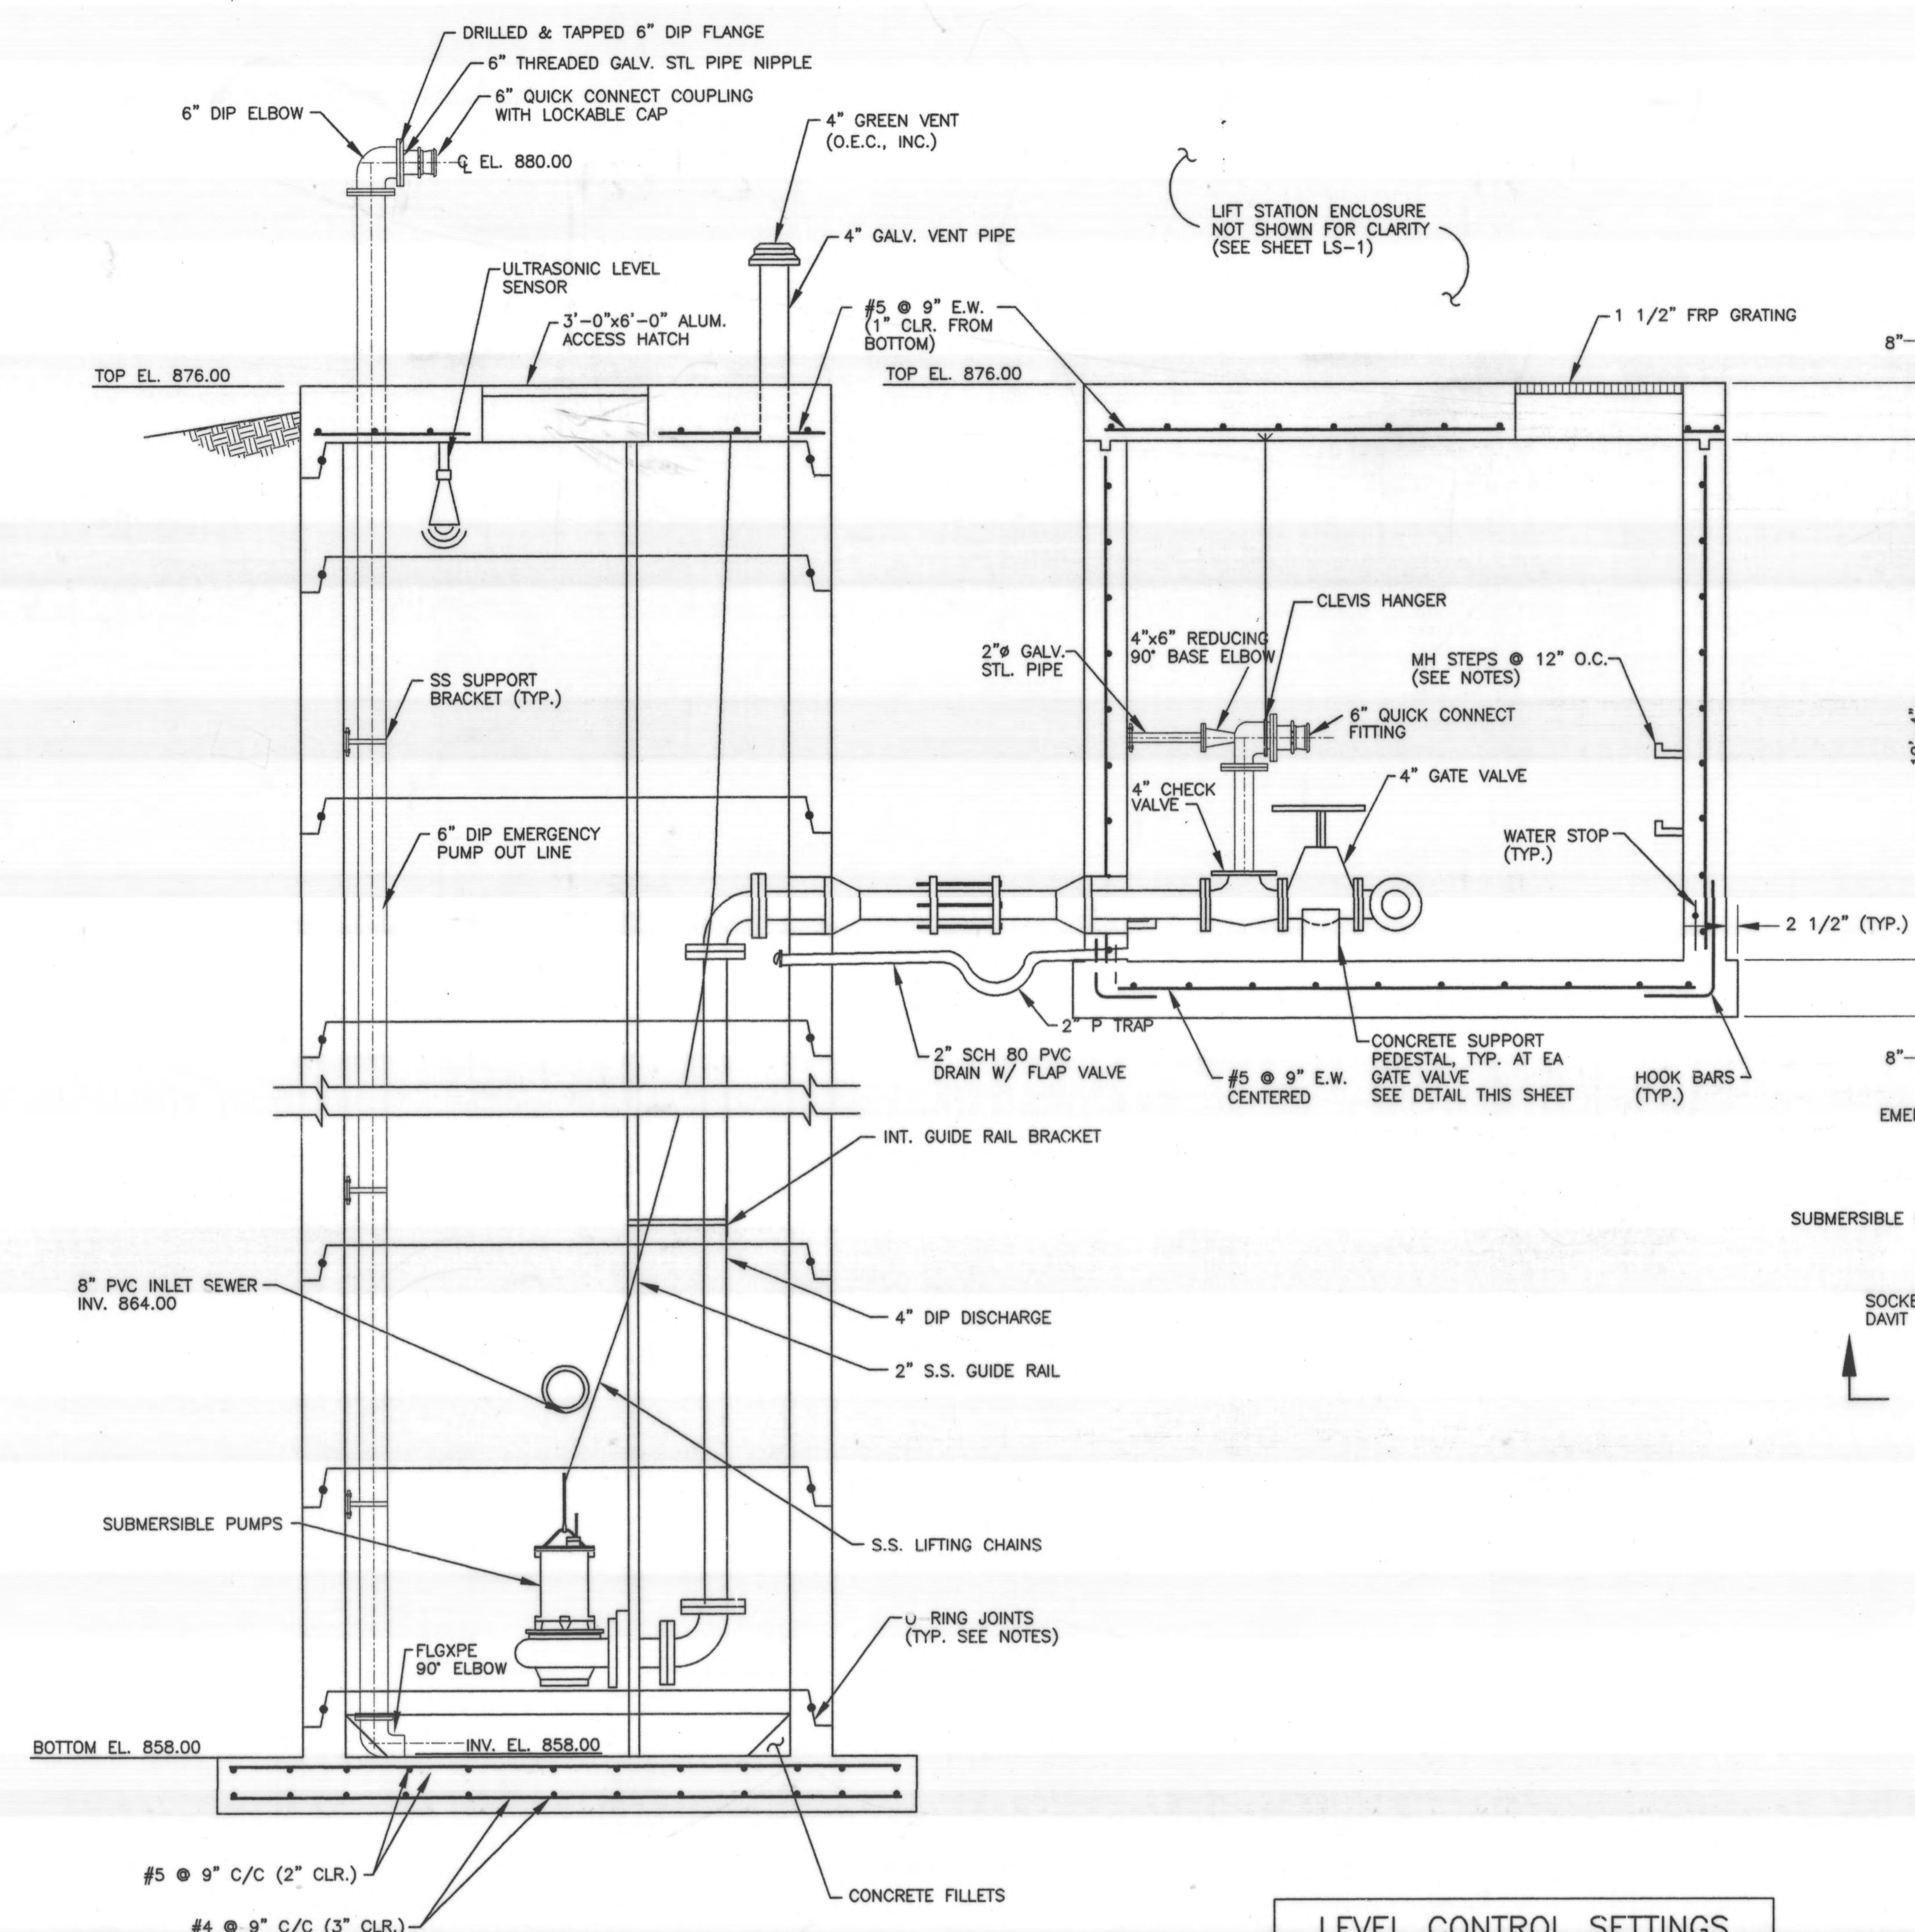


SECTION A-A
N.T.S.

LEVEL CONTROL SETTINGS	
	ELEVATION
PUMPS OFF	860.00
LEAD PUMP ON	862.00
LAG PUMP ON & FAILURE ALARM	863.00
HIGH LEVEL ALARM	863.50

WET WELL

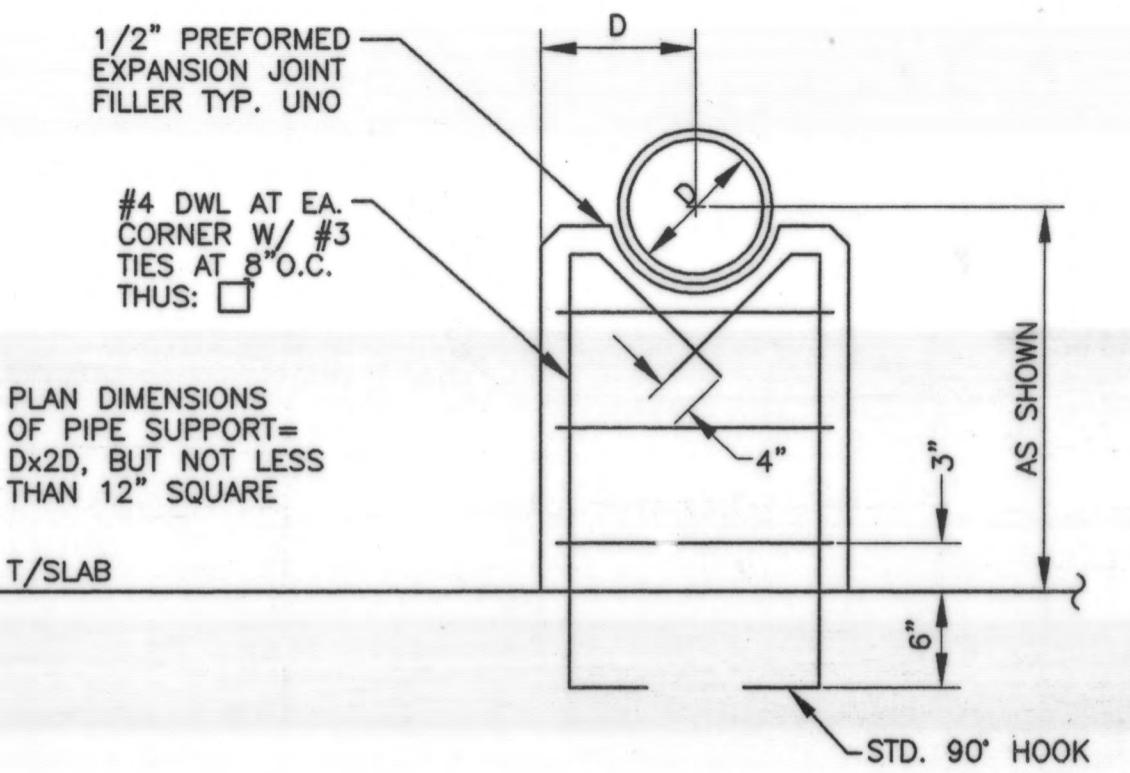


TYP. PIPE SUPPORT DETAIL
N.T.S.

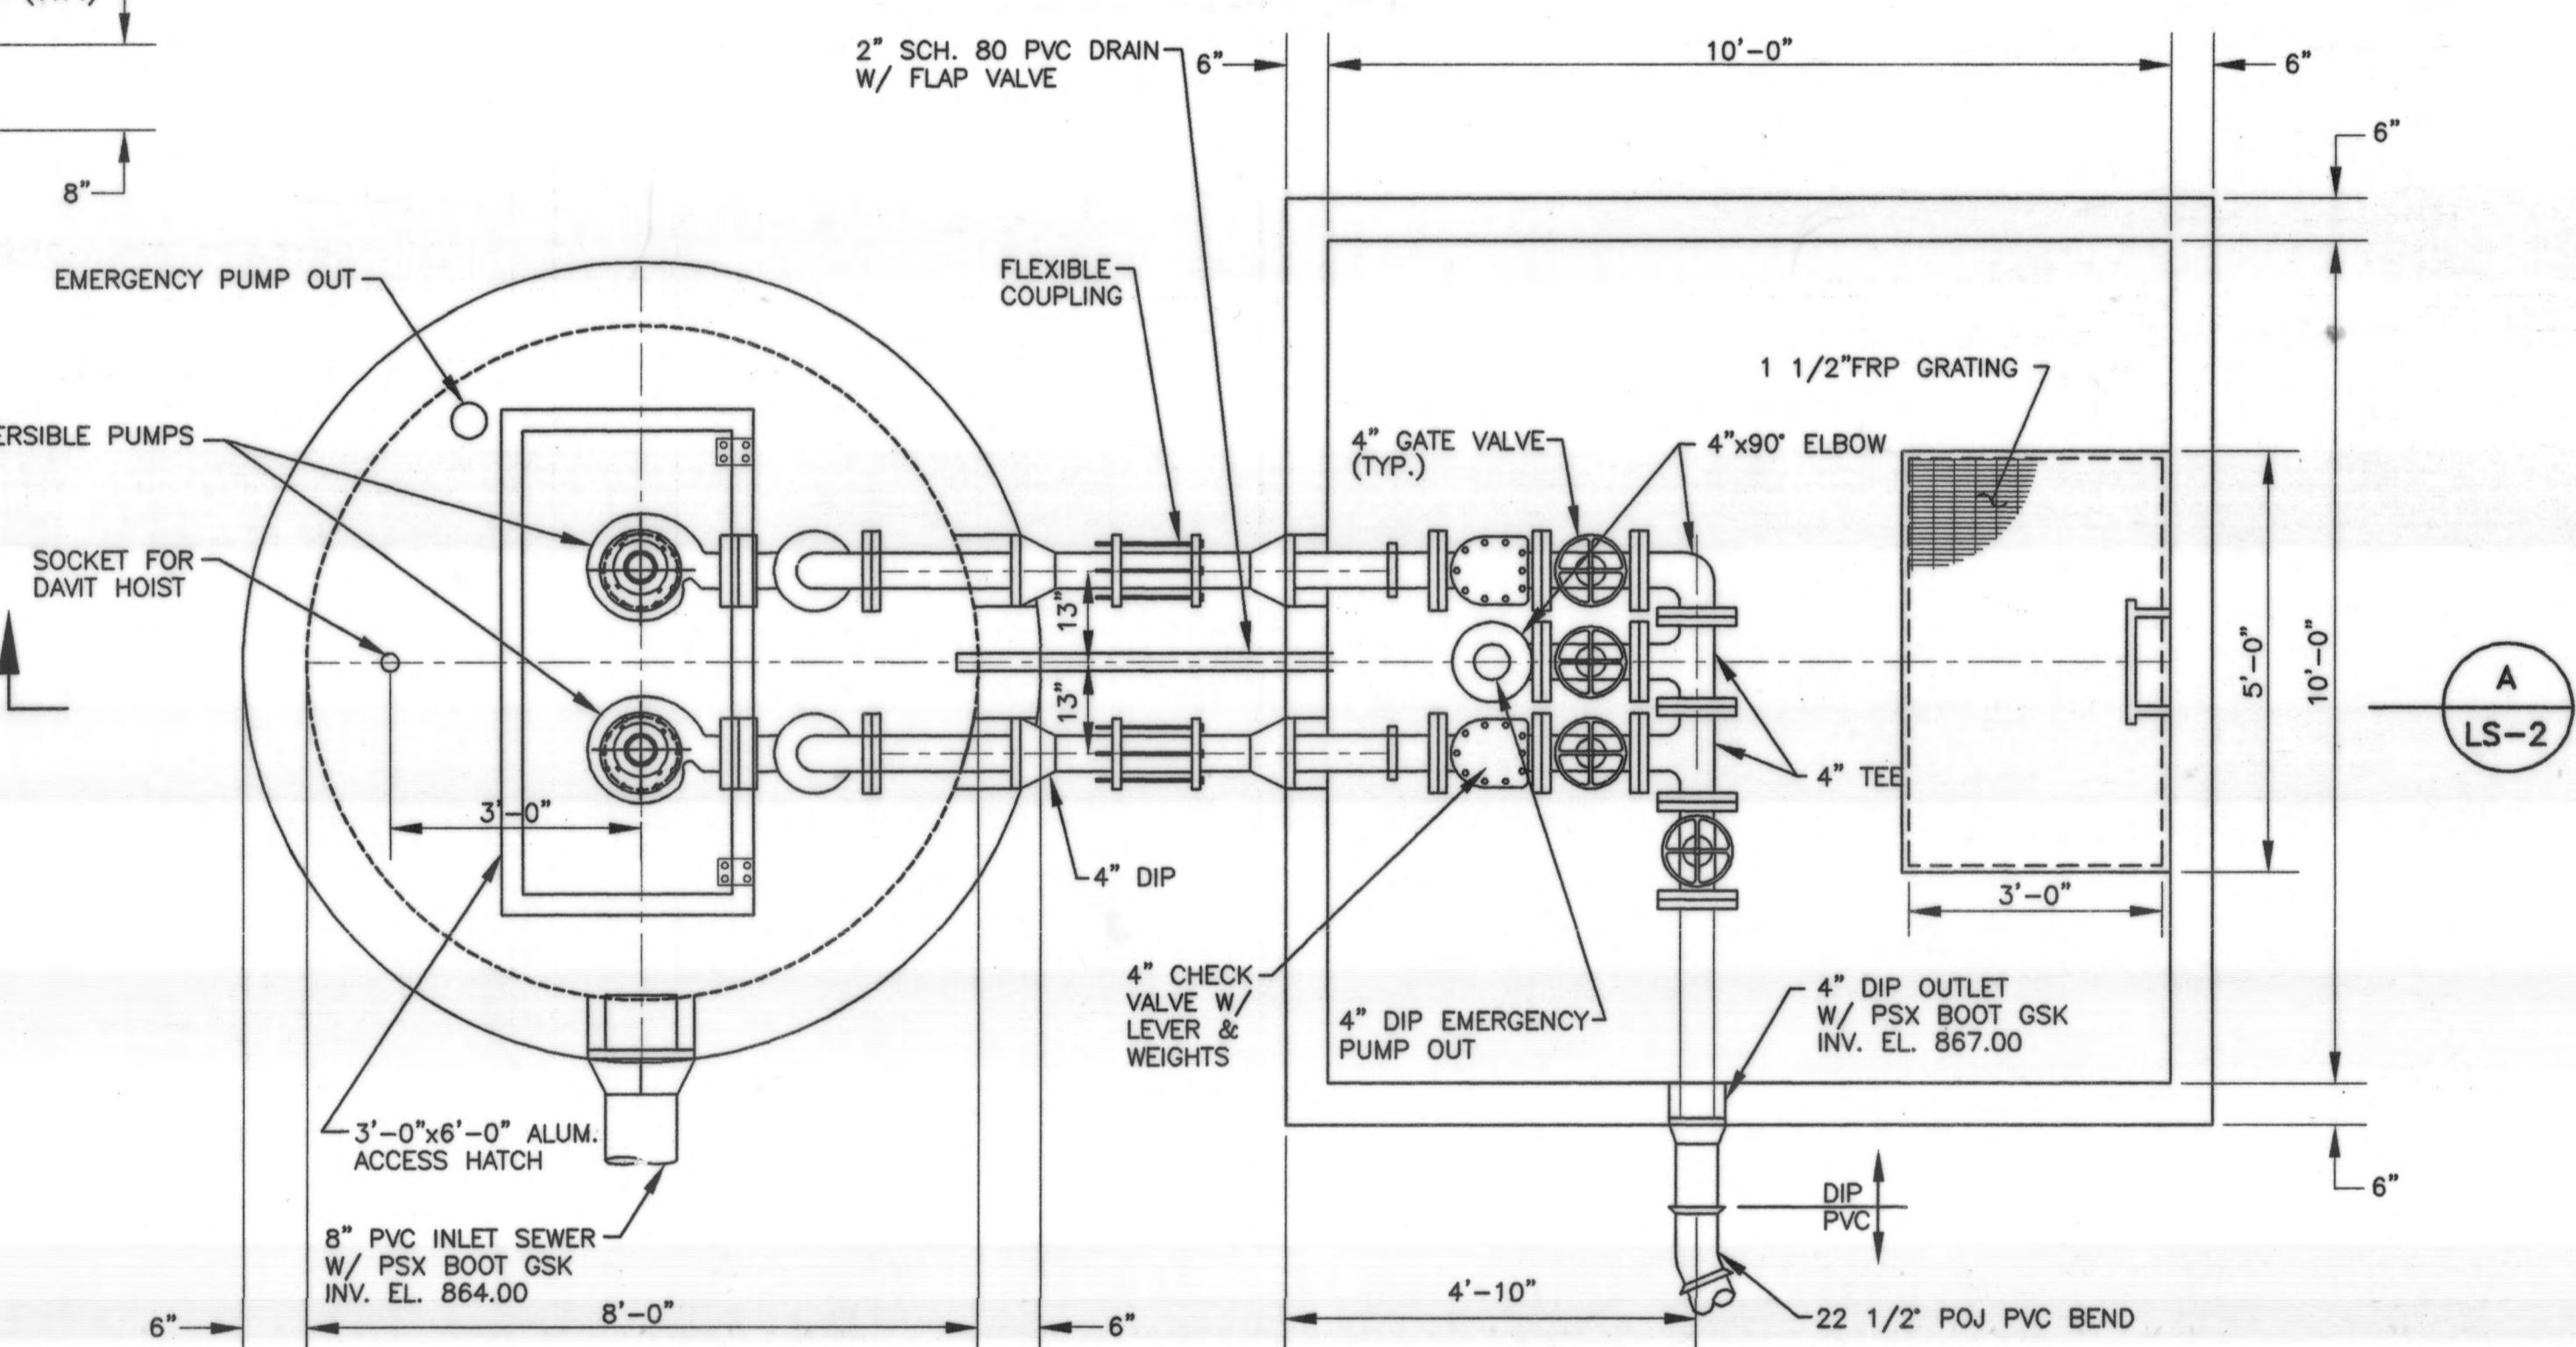

PLAN VIEW
N.T.S.

DELAWARE COUNTY
DELAWARE COUNTY SANITARY ENGINEER

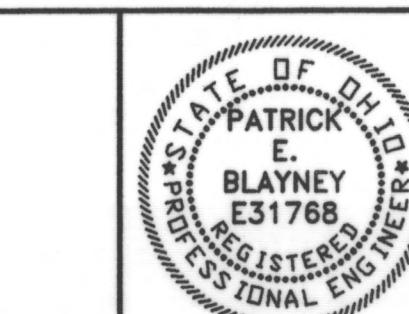

SCIOTO RESERVE
LIFT STATION

SCALE:
SCALE: NONE

GENERAL
DUPLEX SUBMERSIBLE
LIFT STATION

SHEET NO.
LS-3